
PHASE 1 BUSINESS CORE WASTEWATER COLLECTION SYSTEM


CORRALES, NEW MEXICO



MAY 2009

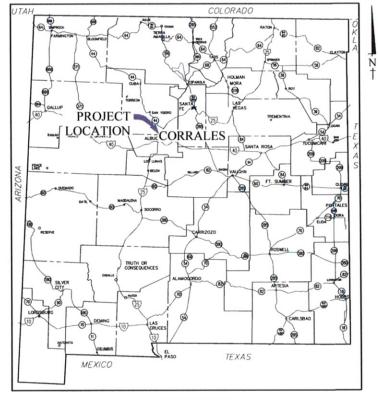

LOCATION MAP

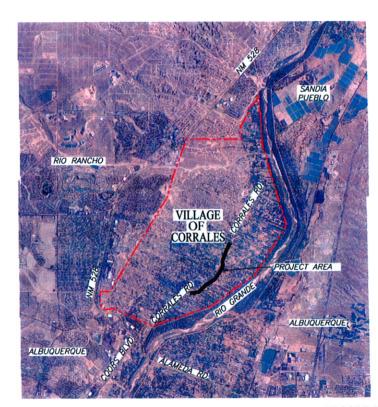

PROJECT AREA MAP

DRAWING INDEX

	Did i will di li bezi
Sheet No.	Sheet Title
G-1	COVER SHEET & PROJECT MAP
G-2	GENERAL NOTES & LEGEND
G-3	DESIGN CALCULATIONS
C-1	KEY MAP
C-2	SURVEY CONTROL POINTS
C-3	STEP SYSTEM PLAN & PROFILE STA. 0+00 TO STA. 5+60
C-4	STEP SYSTEM PLAN & PROFILE STA. 5+60 TO STA. 11+20
C-5	STEP SYSTEM PLAN & PROFILE STA. 11+20 TO STA. 16+80
C-6	STEP SYSTEM PLAN & PROFILE STA. 16+80 TO STA. 22+40
C-7	STEP SYSTEM PLAN & PROFILE STA. 22+40 TO STA. 28+00
C-8	STEP SYSTEM PLAN & PROFILE STA. 28+00 TO STA. 33+60
C-9	STEP SYSTEM PLAN & PROFILE STA. 33+60 TO STA. 39+20
C-10	STEP SYSTEM PLAN & PROFILE STA. 39+20 TO STA. 44+80
C-11	STEP SYSTEM PLAN & PROFILE STA. 44+80 TO STA. 50+40
C-12	STEP SYSTEM PLAN & PROFILE STA. 50+40 TO STA. 56+00
C-13	STEP SYSTEM PLAN & PROFILE STA. 56+00 TO STA. 61+60
C-14	STEP SYSTEM PLAN & PROFILE STA. 61+60 TO STA. 67+20
C-15	STEP SYSTEM PLAN & PROFILE STA. 67+20 TO STA. 72+80
C-16	STEP SYSTEM PLAN & PROFILE STA. 72+80 TO STA. 77+50
DT-1	MANHOLE DETAILS
DT-2	MISCELLANEOUS DETAILS
DT-3	VALVE DETAILS
DT-4	SERVICE CONNECTION DETAILS
TC-1	STANDARD NMDOT TRAFFIC CONTROL SIGN FACE DETAILS
TC-2	TRAFFIC CONTROL PLAN
TC-3	TRAFFIC CONTROL PLAN

RECORD DRAWING:

THE INFORMATION CONTAINED ON THIS DRAWING WAS COMPILED, IN PART, FROM INFORMATION SUPPLIED BY OTHERS. SOUDER, MILLER & ASSOCIATES TAKES NO RESPONSIBILITY FOR INFORMATION SUPPLIED BY OTHERS AND MAKES NO REPRESENTATION TO ITS ACCURACY.

NOTICE OF EXTENDED PAYMENT PROVISION: THIS CONTRACT ALLOWS THE OWNER TO MAKE PAYMENT WITHIN 45 DAYS AFTER SUBMISSION OF AN UNDISPUTED REQUEST FOR PAYMENT.

DATE

COVER SHEET & PROJECT MAP PHASE 1 BUSINESS CORE WASTEWATER COLLECTION SYSTEM

This drawing is incomplete and for construction unless it is stamped, signed and dated

CHECKED BY: SCALE: AS SHOWN



SOUDER, MILLER & ASSOCIATES, 3451 CANDELARIA RD., ALBUQUERQUE, NEW MEXICO 87107 TELE: 505-299-0942 Albuquerque - Las Cruces -Santa Fe, Nil - Cortes, CO - Monticello, UT

GENERAL NOTES GENERAL NOTES

- THERE WILL BE A PERSON OR PERSONS (HEREINAFTER KNOWN AS THE OWNER'S REPRESENTATIVE) CHOSEN BY THE VILLAGE OF CORRALES (HEREINAFTER KNOWN AS THE OWNER) TO ACT AS A CONTACT PERSON BETWEEN THE OWNER AND THE ENGINEER. THE OWNER'S REPRESENTATIVE WILL OBSERVE, AND PROVIDE INFORMATION, AND PROVIDE CRITICAL LOCATIONS THROUGH THE ENGINEER TO THE CONTRACTOR IN THE FIELD.
- SOUDER, MILLER AND ASSOCIATES SHALL HEREINAFTER BE KNOWN AS THE ENGINEER.
 THERE WILL BE A PERSON PROVIDED BY THE ENGINEER THAT WILL ACT AS A RESIDENT
 INSPECTOR WHO WILL BE THE CONTACT FOR QUESTIONS FROM THE CONTRACTOR TO THE
- 3. THE ENGINEER WAIVES ANY AND ALL RESPONSIBILITY AND IS NOT LIABLE FOR PROBLEMS THAT MAY ARISE FROM THE CONTRACTOR'S FAILURE TO FOLLOW THESE DEAWINGS, SPECIFICATIONS, AND THE DESIGN INTERN THEY CONVEY, OR FOR PROBLEMS ARISING FROM FAILURE TO OBTAIN AND/OR FOLLOW THE ENGINEER'S GUIDANCE WITH RESPECT TO ANY ERRORS, OMISSIONS, INCONSISTENCIES, ABRIGUITIES, OR CONFLICTS.
- 4. WHERE PARTICULAR WORK ITEMS ARE NOT SPECIFIED HEREIN OR IN THE PROJECT SPECIFICATIONS, THE CURRENT EDITION OF NEW MEXICO STANDARD SPECIFICATIONS FOR PUBLIC WORKS CONSTRUCTION AND THE APPLICABLE SUPPLEMENTAL SPECIFICATIONS SHALL GOVERN CONSTRUCTION OF THIS PROJECT UNILESS OTHERWISE NOTED.
- IN THE EVENT THAT THE CONTRACTOR ENCOUNTERS ITEMS OF HISTORICAL IMPORTANCE, THE ENGINEER SHALL BE NOTIFIED IMMEDIATELY AND WORK IN THE AREA SHALL IMMEDIATELY CEASE UNTIL THE SITE CAN BE PROPERTY CLEARED.
- 6. ALL WORK IN THE VICINITY OF LIVE STREAMS, WATER IMPOUNDMENTS, WETLANDS OR IRRIGATION SUPPLIES SHALL BE FFECTED IN SUCH A MANNER AS TO MINIMIZE VEGETATION REMOVAL, SOIL DISTURBANCE AND EROSION. CROSSINGS OF LIVE STREAMS WITH HEAVY EQUIPMENT SHALL BE MINIMIZED, AS DETERMINED BY THE ENGINEER. EQUIPMENT REFUELING, MAINTENANCE AND CEMENT OURPING IN THE VICINITY OF WATER COURSES IS STRICTLY PROHIBITED AND SHALL BE PERFORMED IN PROPER CONTAINMENT AREAS.
- 7. IT IS THE RESPONSIBILITY OF THE CONTRACTOR TO FAMILIARIZE HIMSELF WITH THE LOCATION OF ALL UTILITIES LOCATED WITHIN THE LIMITS OF CONSTRUCTION. THE GENERAL LOCATION OF KNOWN EXISTING UTILITIES HAS BEEN SHOWN ON THE CONSTRUCTION DRAWINGS TO INDICATE THAT CAUTION MUST BE EXERCISED WHEN WORKING IN THESE AREAS. IN MANY CASES THE EXACT LOCATION OF THE FACILITIES IS NOT KNOWN. THE CONTRACTOR SHALL BE RESPONSIBLE FOR LOCATING AND PROTECTING ALL OVERHEAD AND UNDERGROUND UTILITIES WITHIN THE VICINITY OF THE NEW CONSTRUCTION. PRIOR TO THE START OF CONSTRUCTION THE CONTRACTOR, WORKING WITH THE RESPECTIVE UTILITY COMPANIES, SHALL ACCURATELY LOCATE AND MARK ALL BURIED FACILITIES, INCLUDING SERVICE LINES. ALL EQUIPMENT LABOR, ETC. NECESSARY TO PROPERTY LOCATE THE EXISTING UTILITIES SHALL BE FURNISHED BY THE CONTRACTOR, THE COST OF WHICH SHALL BE INCLUDED IN THE UNIT PRICES ON VARIOUS BID ITEMS.
- 8. THE CONTRACTOR IS SOLELY RESPONSIBLE FOR CONSTRUCTING THE PROJECT ACCORDING TO CURRENT NEW MEXICO STANDARD SPECIFICATIONS FOR PUBLIC WORKS CONSTRUCTION (NINSSPWC) AWMA SPECS, AND NIMED SPECS AND REGULATIONS UNLESS OTHERWISE NOTED.
- CONTRACTOR IS SOLELY RESPONSIBLE FOR OBTAINING BUILDING PERMITS, UTILITY BORE PERMITS AND ANY OTHER, WHICH HAVE NOT ALREADY BEEN OBTAINED BY THE ENGINEER.
- 10. THE CONTRACTOR SHALL BE RESPONSIBLE FOR ALL REMOVALS REQUIRED BY THE PLANS WHETHER SPECIFICALLY LISTED OR NOT TO COMPLETE THE PROJECT. THIS WORK WILL BE CONSIDERED INCIDENTAL TO CONSTRUCTION AND THE CONTRACTOR WILL NOT RECEIVE ADDITIONAL COMPENSATION FOR UNLISTED REMOVALS. THE CONTRACTOR SHALL DISPOSE OF ALL UNSUITABLE MATERIAL IN AN ENVIRONMENTALLY ACCEPTABLE MANNER AT A LOCATION ACCEPTABLE TO THE OWNER AND ENGINEER.
- 11. THE CONTRACTOR SHALL SALVAGE ANY OBSTRUCTIONS NOTED ON THE CONTRACT DRAWINGS AS WELL AS REUSABLE ITEMS FOUND DURING CONSTRUCTION. SUCH ITEMS, IF ANY, SHALL BE DELIVERED TO THE PROPER OWNER AS DIRECTED BY THE ENGINEER AND/OR OWNER DIRECCONSTRUCTION.
- 12. THE CONTRACTOR WILL NOT BE ALLOWED TO STORE EQUIPMENT IN THE CONSTRUCTION ZONE DURING NON-WORKING HOURS. THE CONTRACTOR IS RESPONSIBLE FOR OBTAINING A STORAGE AREA(S) FOR THIS PROJECT. THE CONTRACTOR WILL BE RESPONSIBLE FOR SITE
- 13. CONTRACTOR IS SOLELY RESPONSIBLE FOR UTILITY LOCATION, PROTECTION, AND VERIFICATION. CONTRACTOR MUST NOTIFY NEW MEXICO ONE CALL SYSTEM, INC. AT 1-800-321-ALER(T), AND ALL LOCAL UTILITY PROVIDERS THREE (3) DAYS BEFORE STARTING UTILITY CONSTRUCTION.
- 14. THROUGHOUT THE LIFE OF THE PROJECT, THE CONTRACTOR SHALL KEEP ANY EXISTING SYSTEM OPERATING. THE CONTRACTOR SHALL REPORT ANY UTILITY SHUTOFFS OF ANY OR ALL CONNECTIONS TO THE OWNER'S REPRESENTATIVE TWENTY-FOUR (24), OR MORE, HOURS IN ADVANCE OF THE SHUT-OFFS. ALL LOCAL RESIDENTS AND BUSINESSES SHALL BE CONTACTED BEFORE ANY DISCONNECTION OF WATER SERVICE. ANY INTERRUPTION OF WATER SERVICE SHALL BE KEPT TO THE MINIMUM LENGTH OF TIME POSSIBLE.
- 15. THE CONTRACTOR SHALL BE RESPONSIBLE FOR OBTAINING A WATER SOURCE FOR CONSTRUCTION. NO DIRECT PAYMENT WILL BE MADE FOR WATER. ALL PERMITS, FEES, EQUIPMENT, HAUL, ETC. RELATIVE TO OBTAINING WATER SHALL BE CONSIDERED INCIDENTAL TO THE VARIOUS BID ITEMS.
- 16. CONTRACTOR SHALL CONFINE ALL CONSTRUCTION OPERATIONS TO THE LIMITS OF THE PROJECT DEFINED IN THESE DRAWINGS, AND IN NO WAY ENCROACH ONTO ADJACENT PROPERTIES, UNLESS LEGAL EASEMENTS ARE PROVIDED. CONTRACTOR SHALL BE HELD SOLELY RESPONSIBLE FOR ANY AGREEMENTS NEEDED, OR DAMAGE CAUSED BY CONSTRUCTION ACTIVITIES TO PUBLIC OR PRIVATE PROPERTY, INCLUDING UTILITIES.
- 17. THE CONTRACTOR SHALL TAKE ANY NECESSARY MEASURES TO PROTECT HORIZONTAL AND VERTICAL CONTROL SURVEY MONUMENTS FROM DAMAGE DURING CONSTRUCTION. IF DURING EXECUTION OF THE PROJECT, THE CONTRACTOR'S ACTIVITIES DISTURB OR DESTROY SUCH MONUMENTS, THE CONTRACTOR SHALL RE-ESTABLISH THEM IN ACCORDANCE WITH THE STANDARDS AND PROCEDURES SET FORTH IN THE "GEODETIC MARK PRESERVATION GUIDEBOOK". FOR MORE INFORMATION CONTACT NGS MARK PRESERVATION CENTER, NOAA (505) 768-3506

- 18. CONTRACTOR SHALL PROTECT AND MAINTAIN ALL EXISTING STRUCTURES FREE OF DUST AND/OR CONSTRUCTION DEBRIS AT ALL TIMES DURING THE EXECUTION OF THE PROJECT. ALL EXISTING AND NEW STRUCTURES SHALL BE CLEANED PRIOR TO FINAL ACCEPTANCE OF THE PROJECT. ALL COSTS RELATED TO THIS ITEM SHALL BE INCIDENTAL TO THE WORK AND NO EXTRA PAYMENT SHALL BE MADE TO THE CONTRACTOR.
- 19. CONTRACTOR SHALL REPAIR ANY EXISTING STRUCTURE OR UTILITY CONDUIT DAMAGED DURING THE EXECUTION OF THE PROJECT, AT NO ADDITIONAL COSTS TO THE OWNER
- 20. THE CONTRACTOR SHALL BE SOLELY RESPONSIBLE FOR THE PROTECTION OF MATERIALS AND EQUIPMENT PRIOR TO AND AFTER THEIR INSTALLATION AS APPLICABLE, UNTIL THE PROJECT'S FINAL ACCEPTANCE BY THE OWNER.
- 21. AS REQUIRED, NOT LESS THAN 5 DAYS PRIOR TO INITIATING ANY WORK, THE CONTRACTOR SHALL SUBMIT A DUST SUPPRESSION AND EROSION CONTROL PLAN FOR THE OWNER'S APPROVAL ALL CONSTRUCTION WORK SHALL BE PERFORMED IN SUCH A MANIER THAT WILL HAVE NO ADVERSE FFFECT UPON ADJACENT PROPERTIES OR PUBLIC ROADWAYS.
- 22. CONTRACTOR SHALL BE SOLELY RESPONSIBLE FOR EROSION CONTROL INCIDENTAL TO THE CONSTRUCTION ACTIVITIES. IN THE EVENT THAT 1 ACRES OF EARTH OR MORE ARE DISTURBED, THE CONTRACTOR SHALL SUBMIT TO THE OWNER'S PROJECT REPRESENTATIVE A STORM WATER POLLUTION PREVENTION PLAN THAT WILL ADDRESS ALL CONSTRUCTION PHASES AND THE PROPOSED POLLUTION PREVENTION AND SEDIMENT CONTROL MEASURES. THIS SHALL BE DONE IN ACCORDANCE WITH THE NATIONAL POLLUTION DISCHARGE ELIMINATION SYSTEM (NPDES) GENERAL PERMIT REQUIREMENT FOR ALL CONSTRUCTION
- 23. THE CONTRACTOR SHALL BE RESPONSIBLE FOR REPORTING AND CLEANUP OF SPILLS ASSOCIATED WITH PROJECT CONSTRUCTION AND SHALL REPORT AND RESPOND TO SPILLS OF HAZARDOUS MATERIALS SUCH AS GASOLINE, DIESEL, MOTOR OILS, SOLVENTS, CHEMICALS, TOXIC AND CORROSIVE SUBSTANCES, AND OTHER MATERIALS WHICH MAY BE A THREAT TO PUBLIC HEALTH OR THE ENVIRONMENT. THE CONTRACTOR SHALL BE RESPONSIBLE FOR REPORTING PAST SPILLS ENCOUNTERED DURING CONSTRUCTION AND OF CURRENT SPILLS NOT ASSOCIATED WITH CONSTRUCTION. REPORTS SHALL BE MADE IMMEDIATELY TO THE NM ENVIRONMENT DEPARTMENT EMERGENCY RESPONSE TEAM AT (505) B27-4308 OR (505) 470-3657 AND TO THE ENGINEER. ANY UNREPORTED SPILLS IDENTIFIED AFTER CONSTRUCTION AND THE ASSOCIATED CLEANUP COSTS WILL BE THE RESPONSIBILITY OF THE CONTRACTOR.
- 24. THE CONTRACTOR SHALL PREPARE AND MAINTAIN UP-TO-DATE "AS-BUILT" DRAWINGS. UPDATING SUCH DRAWINGS SHALL BE DONE NOT LESS THAN ONCE EVERY WEEK, THE OWNER'S ENGINEER SHALL BE ALLOWED TO REVIEW THESE DRAWINGS AT ANY TIME DURING CONSTRUCTION. PRIOR TO FINAL ACCEPTANCE OF THE PROJECT, THE CONTRACTOR SHALL SUBMIT TO THE ENGINEER COMPLETE AS-BUILT DRAWINGS.
- THE CONTRACTOR WILL UPDATE "AS-BUILT DRAWINGS" FOR THE PROJECT AND DELIVER TWO (2) SETS OF THESE DRAWINGS WITH REDLINES TO THE ENGINEER UPON COMPLETION OF THE CONSTRUCTION.
- 26. CONTRACTOR SHALL SUBMIT ASTM OR AASHTO CERTIFICATES OF MATERIAL'S COMPLIANCE TO THE ENGINEER, NO LESS THAN 5 DAYS PRIOR TO INITIATING ANY WORK INVOLVING SUCH MATERIALS.
- ANY UTILITIES FOR THIS PROJECT SHALL BE INSTALLED TO THE MINIMUM COVER AS SHOWN ON THE CONSTRUCTION DRAWINGS. THIS INCLUDES ANY CROSSING SERVICES OR LATERALS INSTALLED. EXCEPTIONS MUST BE AUTHORIZED BY THE ENGINEER.
- 28. ALL INSTALLED UTILITY MAINS, LATERALS, AND SERVICES SHALL BE MARKED WITH TRACER WIRE TAPED TO TOP OF PIPE AND DETECTABLE WARNING TAPE WHERE APPLICABLE AT LEAST EIGHTEEN (18) INCHES ABOVE BURIED PIPE, AS PER SPECIFICATIONS AND THESE DRAWINGS.
- 29. ALL INSTALLED OR OPENED WATERLINES & MATERIALS SHALL BE DISINFECTED PRIOR TO PLACING IN SERVICE.
- 30. ALL BEDDING MATERIAL SHALL BE GRANULAR AND FREE—DRAINING, HAVE A MAXIMUM GRAIN SIZE THAT DOES NOT EXCEED 3/8 INCH, AND BE ACCEPTABLE TO THE ENGINEER.
- 31. OVER-EXCAVATION OF TRENCHES SHALL NOT BE PERFORMED UNLESS IT IS DETERMINED. TO THE SATISFACTION OF THE ENGINEER THAT THE SUBSOIL IS NOT SUITABLE FOR PIPE BEDDING AND MUST BE REPLACED WITH IMPORTED FILL OVER-EXCAVATION PERFORMED UNNECESSARILY BY THE CONTRACTOR SHALL BE REMEDIED WITH CLASSIFIED FILL AND COMPACTION AS REQUIRED BY THE SPECIFICATIONS, AT THE CONTRACTOR'S EXPENSE.
- 32. PADDING AND BACK FILL MATERIAL, IF REQUIRED SHALL BE OBTAINED BY THE CONTRACTOR AT HIS EXPENSE. SEPARATE PAYMENT WILL NOT BE MADE FOR PADDING AND BACK FILL MATERIAL OR HAUL SHALL BE CONSIDERED INCIDENTIAL TO THE VARIOUS WORK ITEMS. THE CONTRACTOR SHALL SECURE A SUITABLE PADDING AND BACK FILL MATERIAL IS REQUIRED TO COMPLETE THE PROPERTY.
- 33. BACK FILL DENSITY TESTS SHALL BE PERFORMED HORIZONTALLY FOR EACH 1000 LINEAR FEET OF PIPELINE, OR ANY STRUCTURE THAT REQUIRES COMPACTED FOUNDATION OR CONTROLLED BACK FILL. ADDITIONAL COMPACTION TESTS SHALL ALSO BE TAKEN EVERY 3 VERTICAL FEET OF BACK FILL
- 34. ALL AREAS DISTURBED BY THE CONSTRUCTION ACTIVITIES OF THIS PROJECT SHALL BE RESTORED, RE-GRADED IN A MANNER ACCEPTABLE TO THE OWNER AND ENGINEER.
- 35. EXCESS MATERIAL, IF APPLICABLE, SHALL BE REMOVED FROM THE SITE AND PROPERLY DISPOSED OF BY THE CONTRACTOR AT HIS EXPENSE.
- 36. OBSTRUCTIONS REMOVED FROM THE WORK AREAS SHALL BE DISPOSED OF BY THE CONTRACTOR. DISPOSAL OF USABLE MATERIALS (E.G., EXCESS DIRT, GRAVEL, ETC.) SHALL BE AT A SITE DESIGNATED BY THE OWNER DURING CONSTRUCTION. THE DISPOSAL SITE FOR EXCESS MATERIAL MUST BE APPROVED BY THE PROJECT MANAGER AND ENGINEER. IT SHALL BE THE RESPONSIBILITY OF THE CONTRACTOR TO LOCATE A DISPOSAL SITE FOR NON-USABLE MATERIALS (E.G. BRUSH, CONCRETE). ACCORDING TO THE NMED. WASTE PAYEMENT AND CONCRETE ARE NOT CONSIDERED REGULATED WASTE AND CAN BE DISPOSED OF FOR USE AS FILL OR EROSION CONTROL IF A SITE CAN BE LOCATED. ALL OTHER WASTE (E.G. TRASH, BRUSH, ETC.) SHALL BE DISPOSED OF FOR MORPOAL SITE OF MUST BE APPROVED BY THE PROJECT MANAGER AND OWNER PRIOR TO DISPOSAL OF ANY WASTE.

ABBREVIATIONS

ABBREVIATIONS				
CI CO D.I. DIA. E.G. EXIST. FIG. FL FNPT GALV. HDPE I.D. LF MAX. mA MIN. M.J. M.J. N.O.A.A. NMED	AMERICAN WATER WORKS ASSOCIATION CENTERLINE CAST IRON	xx	EXISTING FENCE (MIRE, WOOD, ETC.) EXISTING CHAIN LINK FENCE	
	CLEANOUT DUCTILE IRON DIAMETER	— ОНЕ — ОНЕ — ОНЕ	EXISTING OVERHEAD ELECTRIC, W/ POLE & GUY WIRE	
	DIAMETER FOR EXAMPLE EXISTING	UGE	EXISTING UNDERGROUND ELECTRIC	
	FIGURE FLANGE	OHT	EXISTING OVERHEAD TELEPHONE LINE	
	FEMALE NATIONAL PIPE THREAD GALVANIZED	UGT UGT	EXISTING UNDERGROUND TELEPHNE UNE W/ PEDESTAL OR MH	
	HIGH DENSITY POLYETHYLENE PIPE INNER DIAMETER	— G — <u>□</u> G —	EXISTING GAS LINE W/ METER	
	LINEAR FEET MAXIMUM MILLIAMP (ONE THOUSANDTH OF AN AMP) MINIMUM MECHANICAL JOINT MANHOLE MANHOLE NATIONAL OCEANIC & ATMOSPHERIC ADMINISTRATION NEW MEXICO ENVIRONMENT DEPARTMENT	UGTV UGTV	EXISTING UNDERGROUND CABLE TV W/ PEDESTAL	
		FO FO	EXISTING UNDERGROUND FIBER OPTIC LINE	
		笠	EXISTING FIRE HYDRANT	
		(44)	EXISTING WATER METER	
NTS O.D. PE	NOT TO SCALE OUTER DIAMETER POLYETHYLENE	®	EXISTING WELL .	
psi PVC	POUNDS PER SQUARE INCH POLYVINYL CHLORIDE		EXISTING MAJOR CONTOUR	
R RCP	RADIUS REINFORCED CONCRETE PIPE		EXISTING MINOR CONTOUR	
ROW SCH.	RIGHT OF WAY SCHEDULE	•	EXISTING MONITOR WELL	
SPECS STD.	SPECIFICATIONS STANDARD		EXISTING MAILBOX	
		Ø	EXISTING ELECTRIC METER	
		-0-	EXISTING SIGN	
		•	SURVEY CONTROL POINT OR BENCHMARK	
PROJECT SPECIFIC NOTES 1. THE 6" STEP COLLECTION MAIN SHALL BE INSTALLED BY DIRECTIONAL DRILLING IN 500 FOOT MAXIMUM SEGMENTS. 6" HDPE "ROLL" PIPE SHALL BE USED. 2. THE 2" AND 3" COLLECTION SYSTEM LATERALS AND		2*	NEW 2" HOPE PIPE	
		3" HDPE	NEW 3" HOPE PIPE (LATERALS)	
		6" STEP	NEW 6" STEP LINE	
			NEW HOPE CAP & STUB	
SERVICE CONNECTIONS SHALL BE INSTALLED BY OPEN TRENCH METHOD, STEEL CASING IS REQUIRED FOR ALL		Z •	NEW BALL VALVE	
	BENEATH CORRALES ROAD (STATE HIGHWAY 448).	t	NEW AIR RELEASE VALVE	

LEGEND

0

SINGLE WW SINGLE SERVICE LINE, DIAMETER IN INCHES AS INDICATED DOUBLE WW SINGLE SERVICE LINE, DIAMETER IN INCHES AS INDICATED

PAVED ROAD

NEW SEWER CLEANOUT

NOTICE OF EXTENDED PAYMENT PROVISION: THIS CONTRACT ALLOWS THE OWNER TO MAKE PAYMENT WITHIN 45 DAYS AFTER SUBMISSION OF AN UNDISPUTED REQUEST FOR PAYMENT.



 REVISIONS

 BY
 DATE
 DESC
 DATE:
 August 3, 2010
 DRAWN BY:
 MLS, SBH

 CHECKED BY:
 LTH

 SCALE:
 AS SHOWN
 APPROVED BY:
 JAM



SOUDER, MILLER & ASSOCIATES, 3451 CANDELARIA RD., ALBUQUERQUE, NEW MEXICO 87107 TELE: 505-299-0942 Albuquerque - Las Cruces -Santa Fe, NM - Cortes, CO - Monticello, UT MOREZ OF

DOTRINGO PANNENT PROVISION
THIS CONTRACT ALLOWS THE OWN
TO MAKE PIXTURENT WITHIN 45 OR

AFER SUBMISSION OF AN

(MOSPYTED PROVEST FOR

PANNENT.

PIPING BENEATH CORRALES ROAD (STATE HIGHWAY 448)

FROM 9:00 AM TO 3:30 PM AND 8:30 PM TO 5:30 AM

4. SINGLE LANE ACCESS MUST BE AVAILABLE AT ALL

5. ACCESS IMPACTS TO ALL PROPERTIES AND ROADS

INTERSECTING CORRALES ROAD (STATE HIGHWAY 448)

PER THE NMDOT DISTRICT 3 TRAFFIC ENGINEER.

TIMES ON CORRALES ROAD (STATE HIGHWAY 448).

SHALL BE MINIMIZED.

HOURS OF CONSTRUCTION ARE LIMITED TO WEEKDAYS


GENERAL NOTES & LEGEND


PHASE 1 BUSINESS CORE WASTEWATER COLLECTION SYSTEM


CORRALES, NEW MEXICO

This drawing is incomplete and not to be used for construction unless it is stamped, signed and dated

SHEET G-2

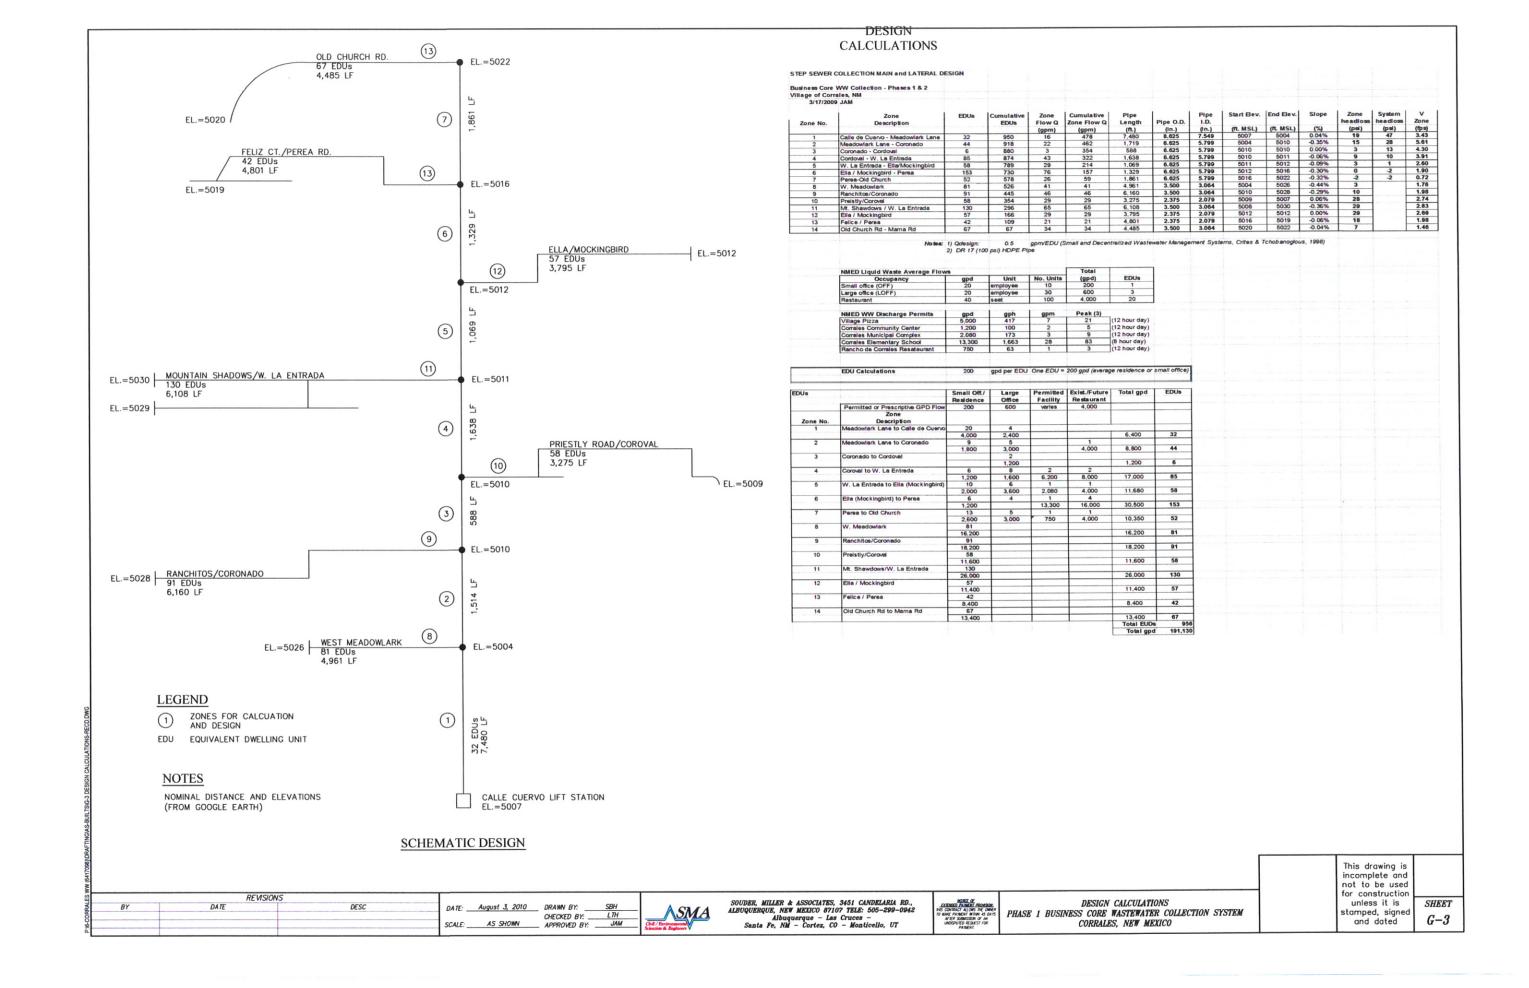

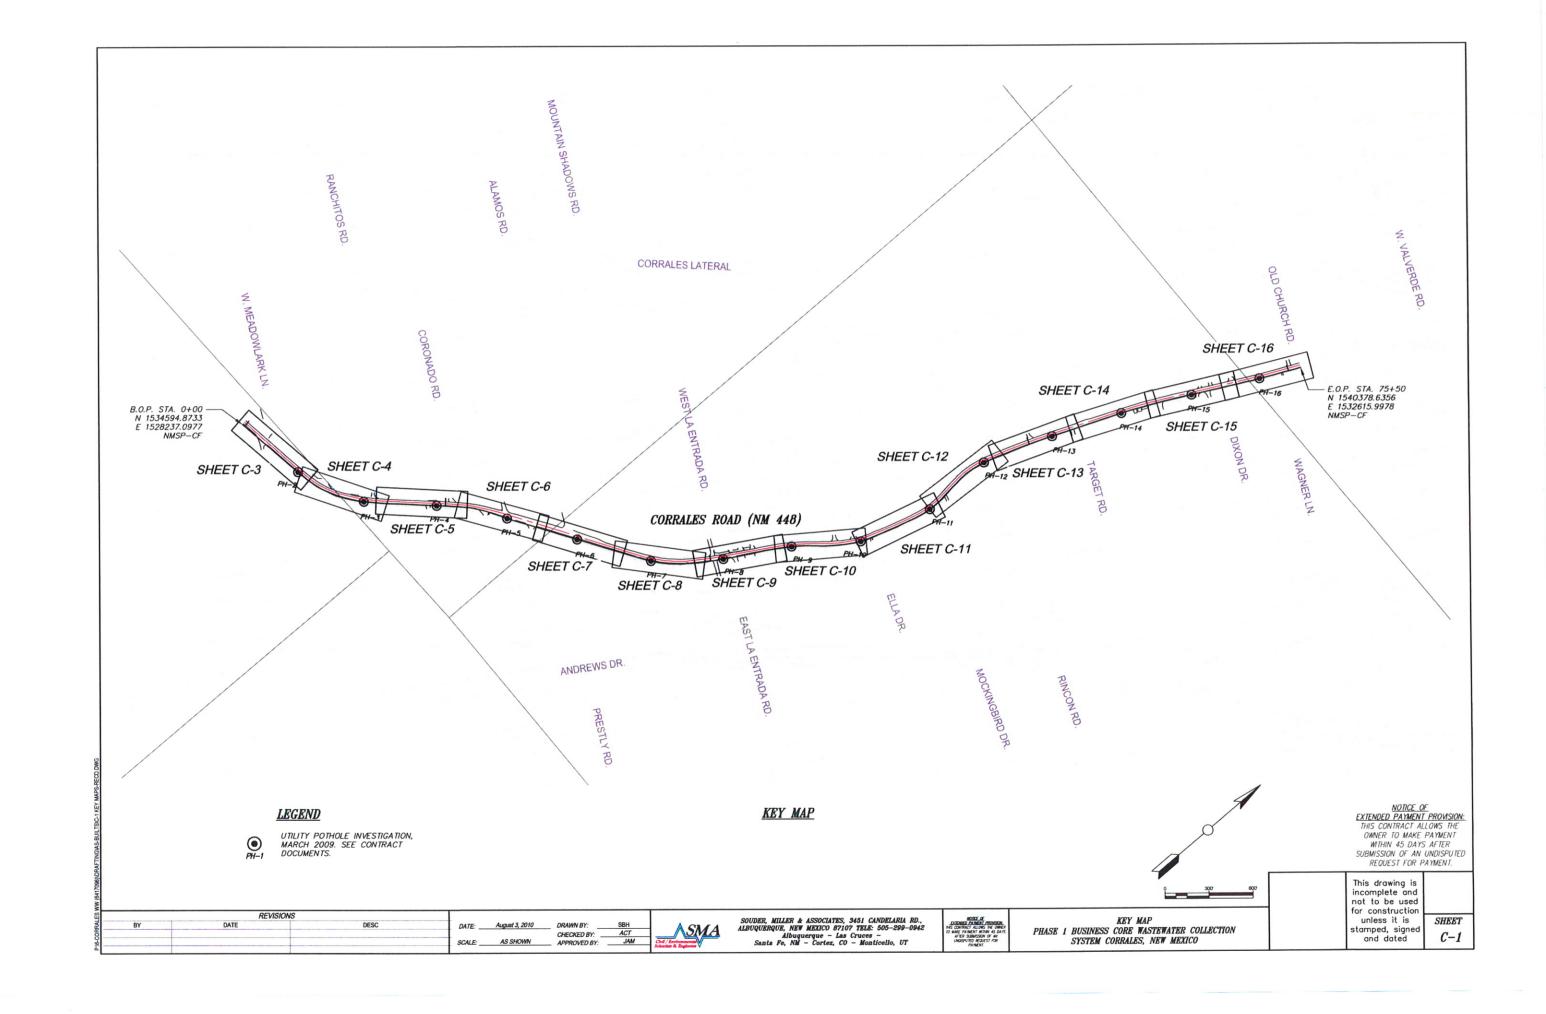

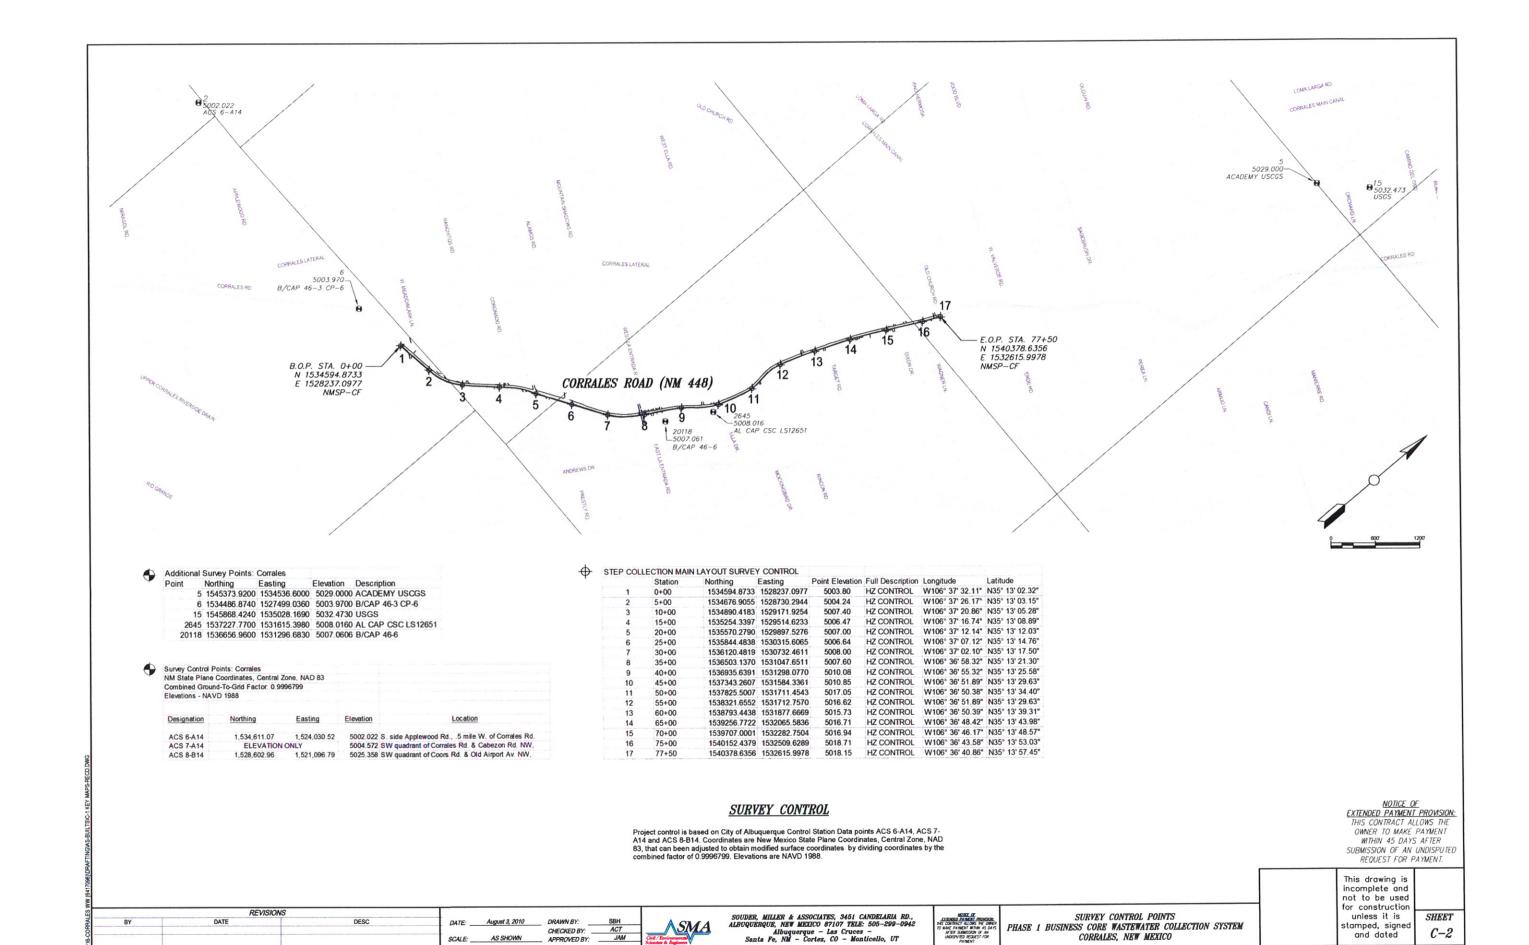

PHASE 1 BUSINESS CORE WASTEWATER COLLECTION SYSTEM

CORRALES, NEW MEXICO

stamped, signed

and dated

C-2

DATE: August 3, 2010


SCALE: AS SHOWN


DRAWN RY


CHECKED BY:


APPROVED BY:


JAM

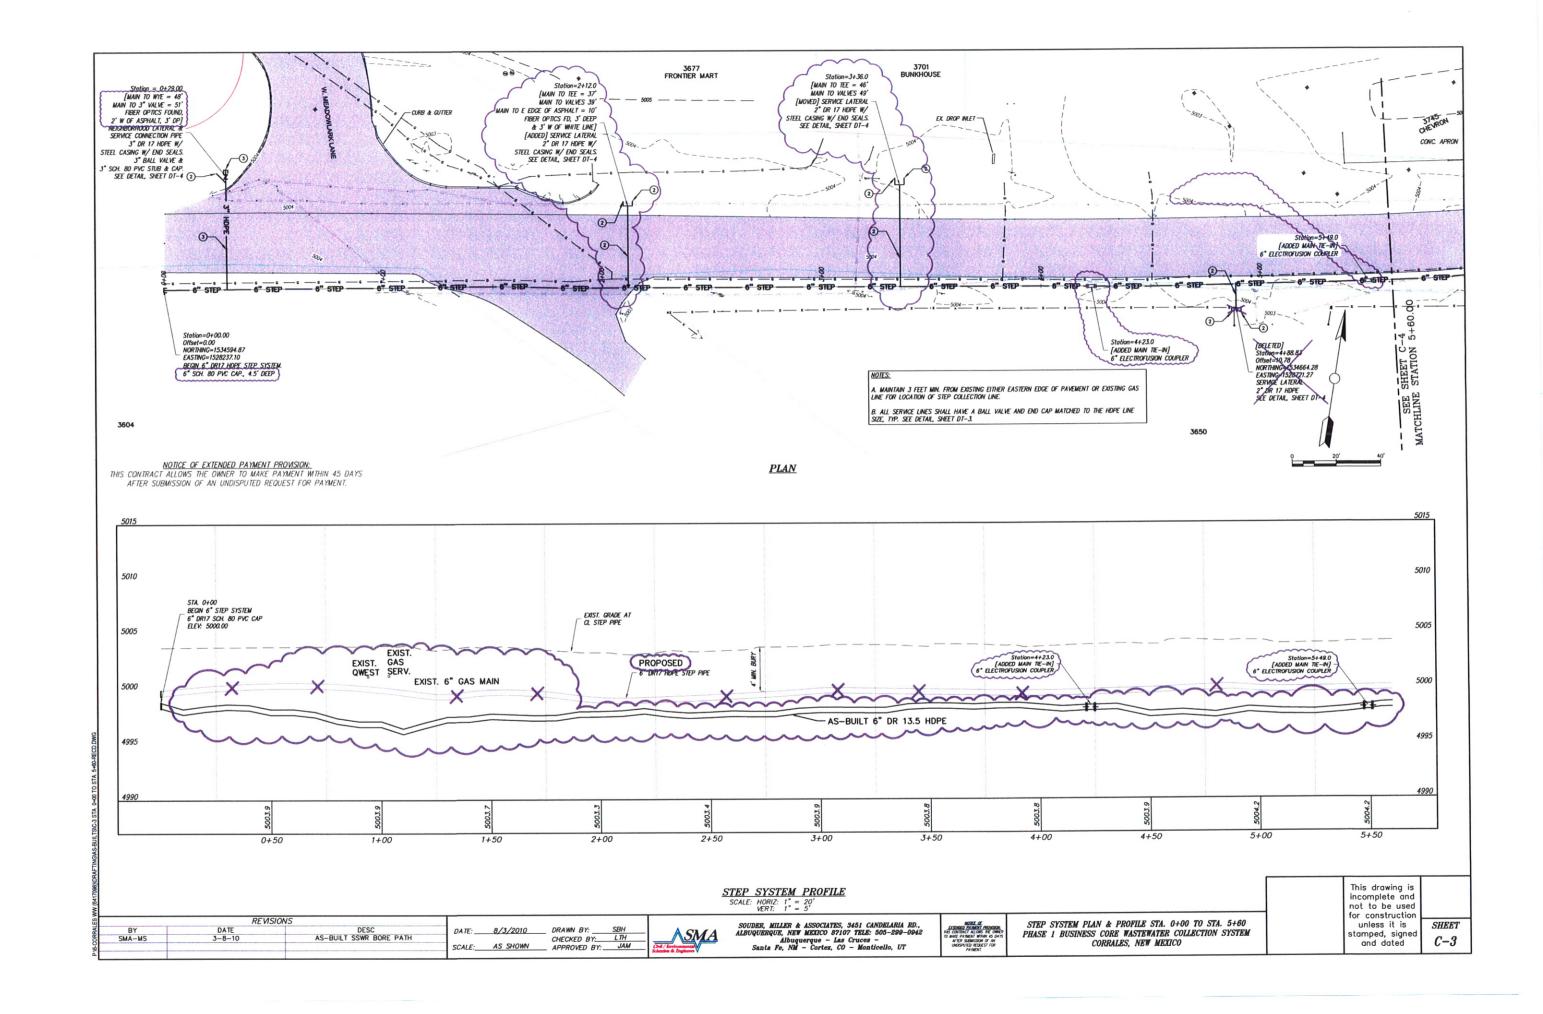


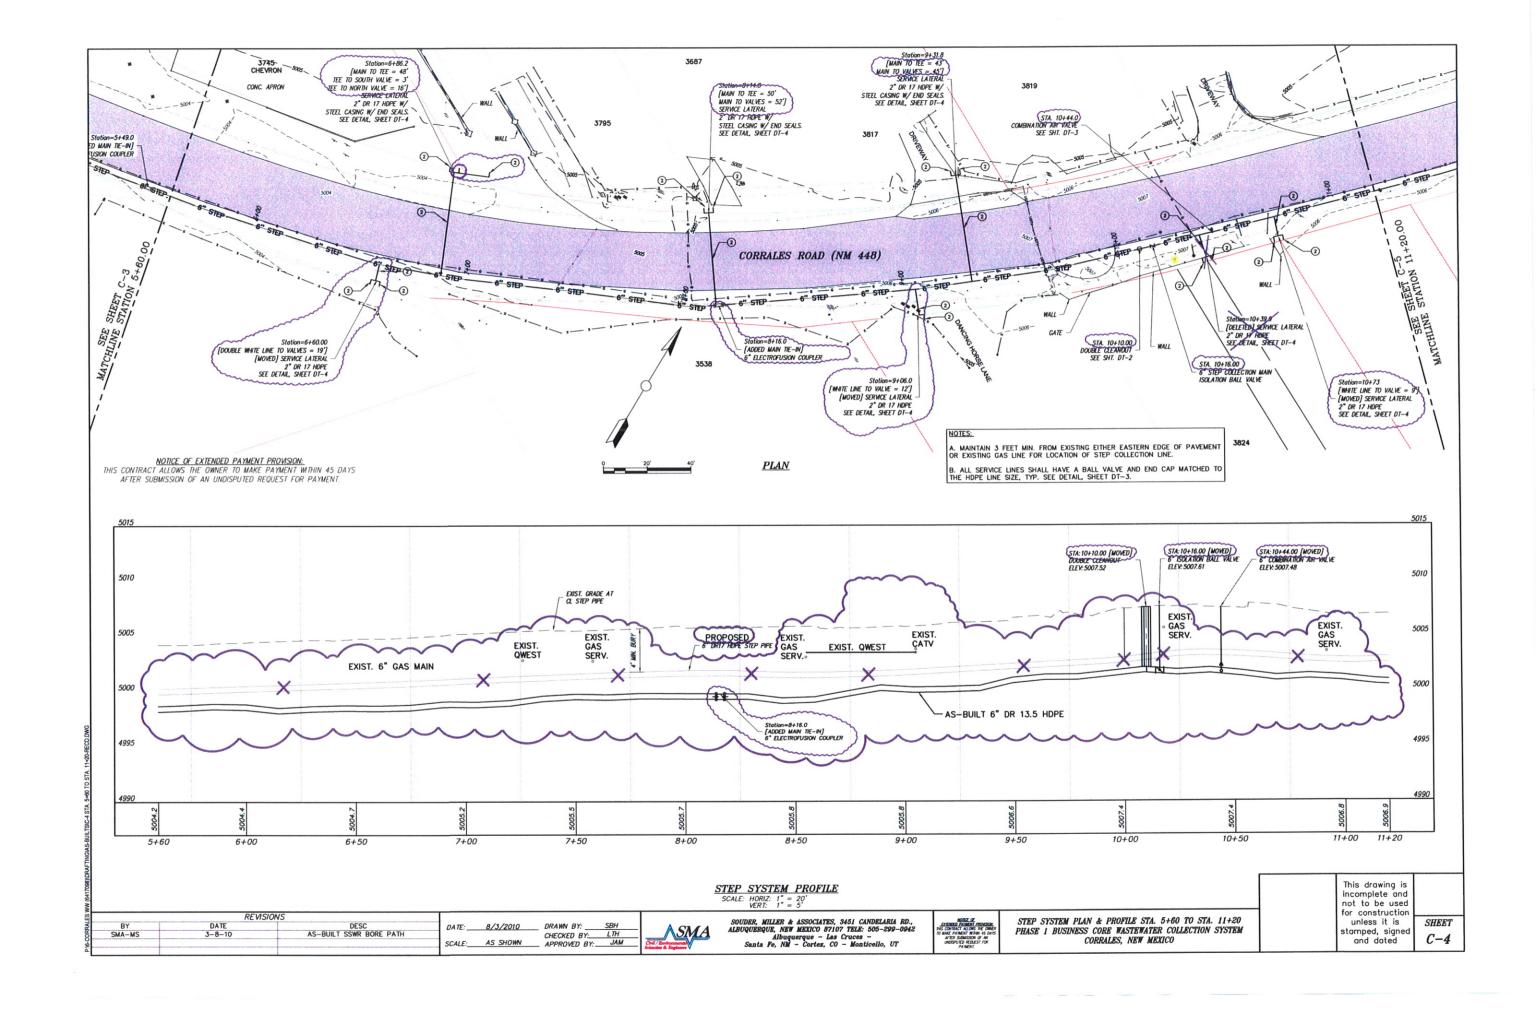


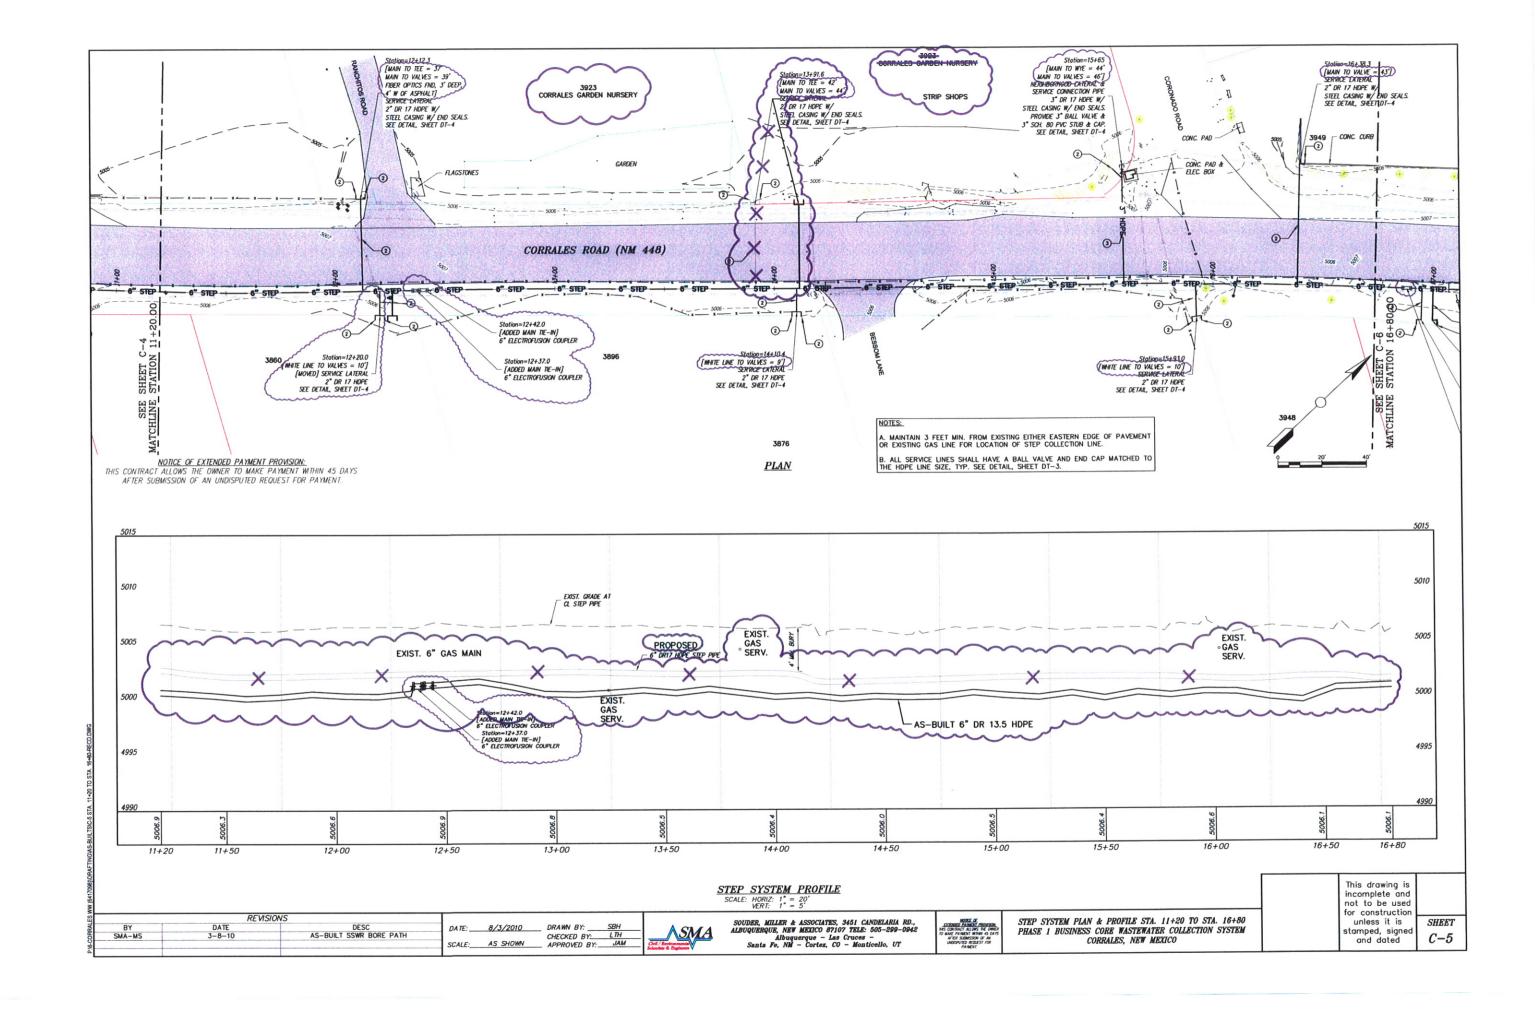


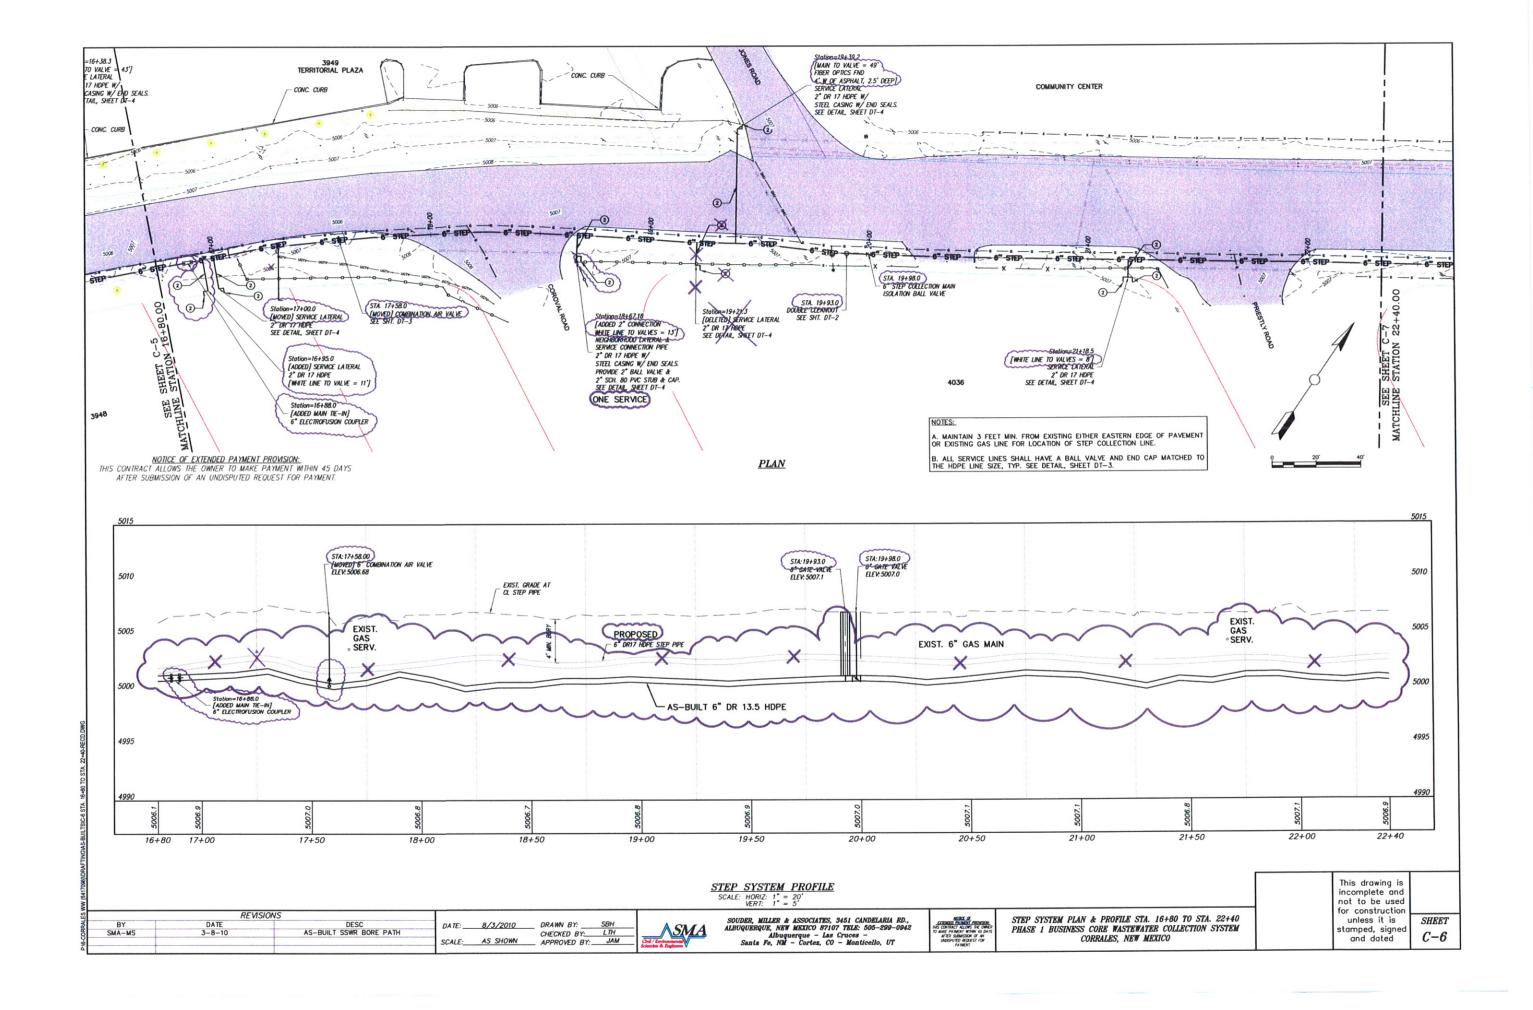


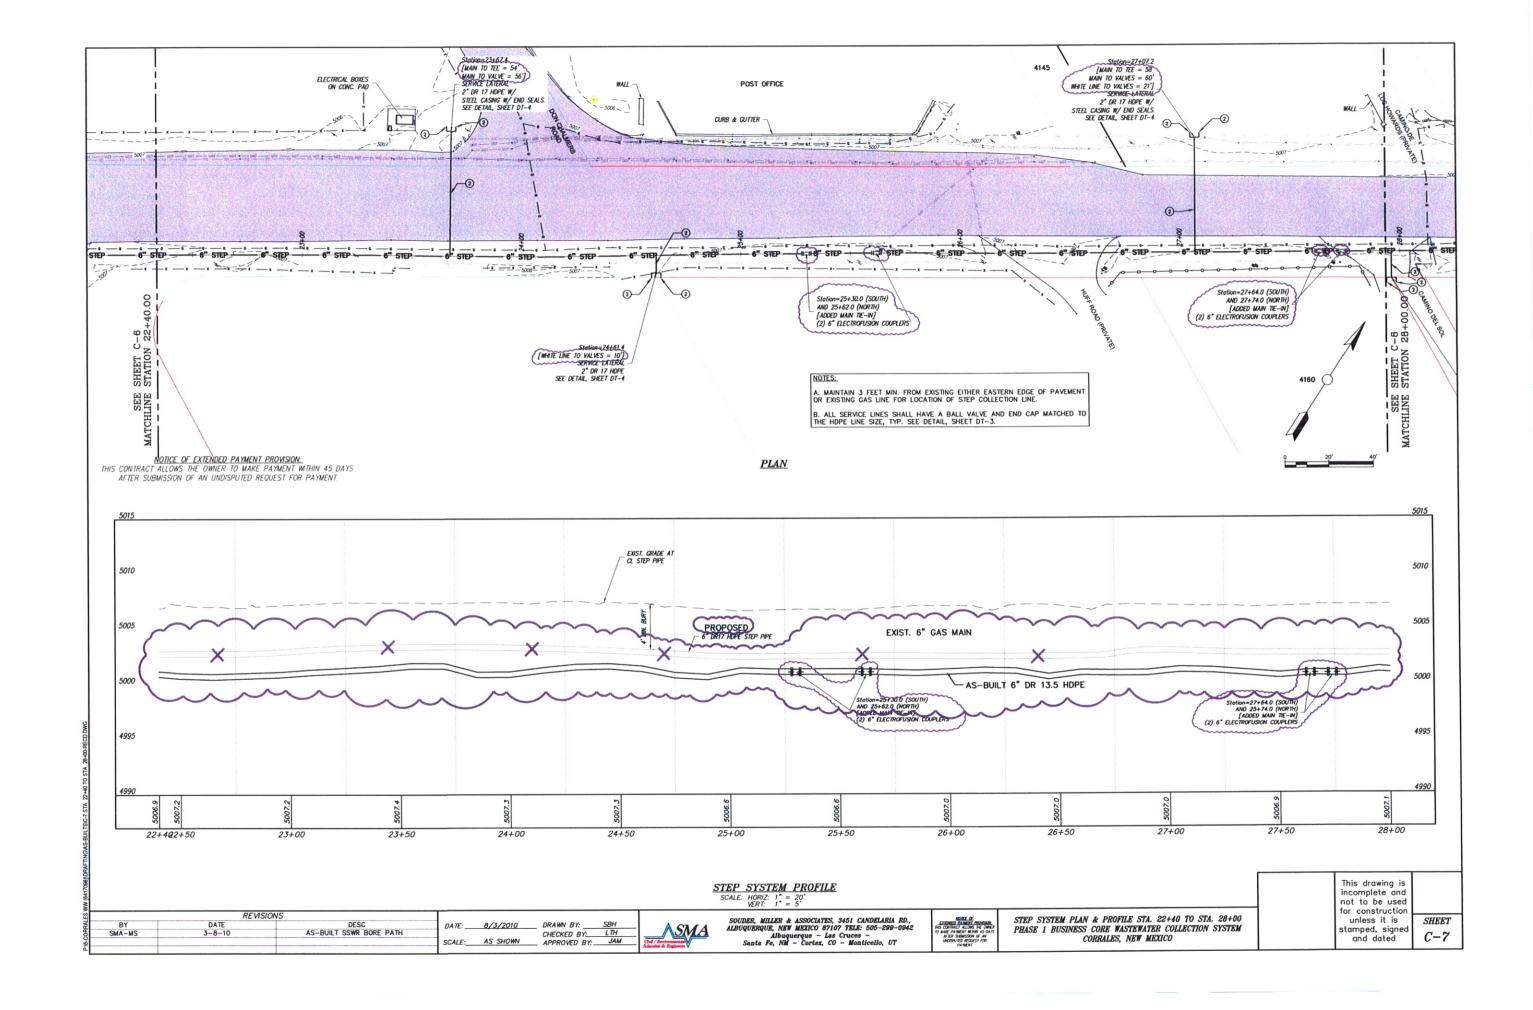


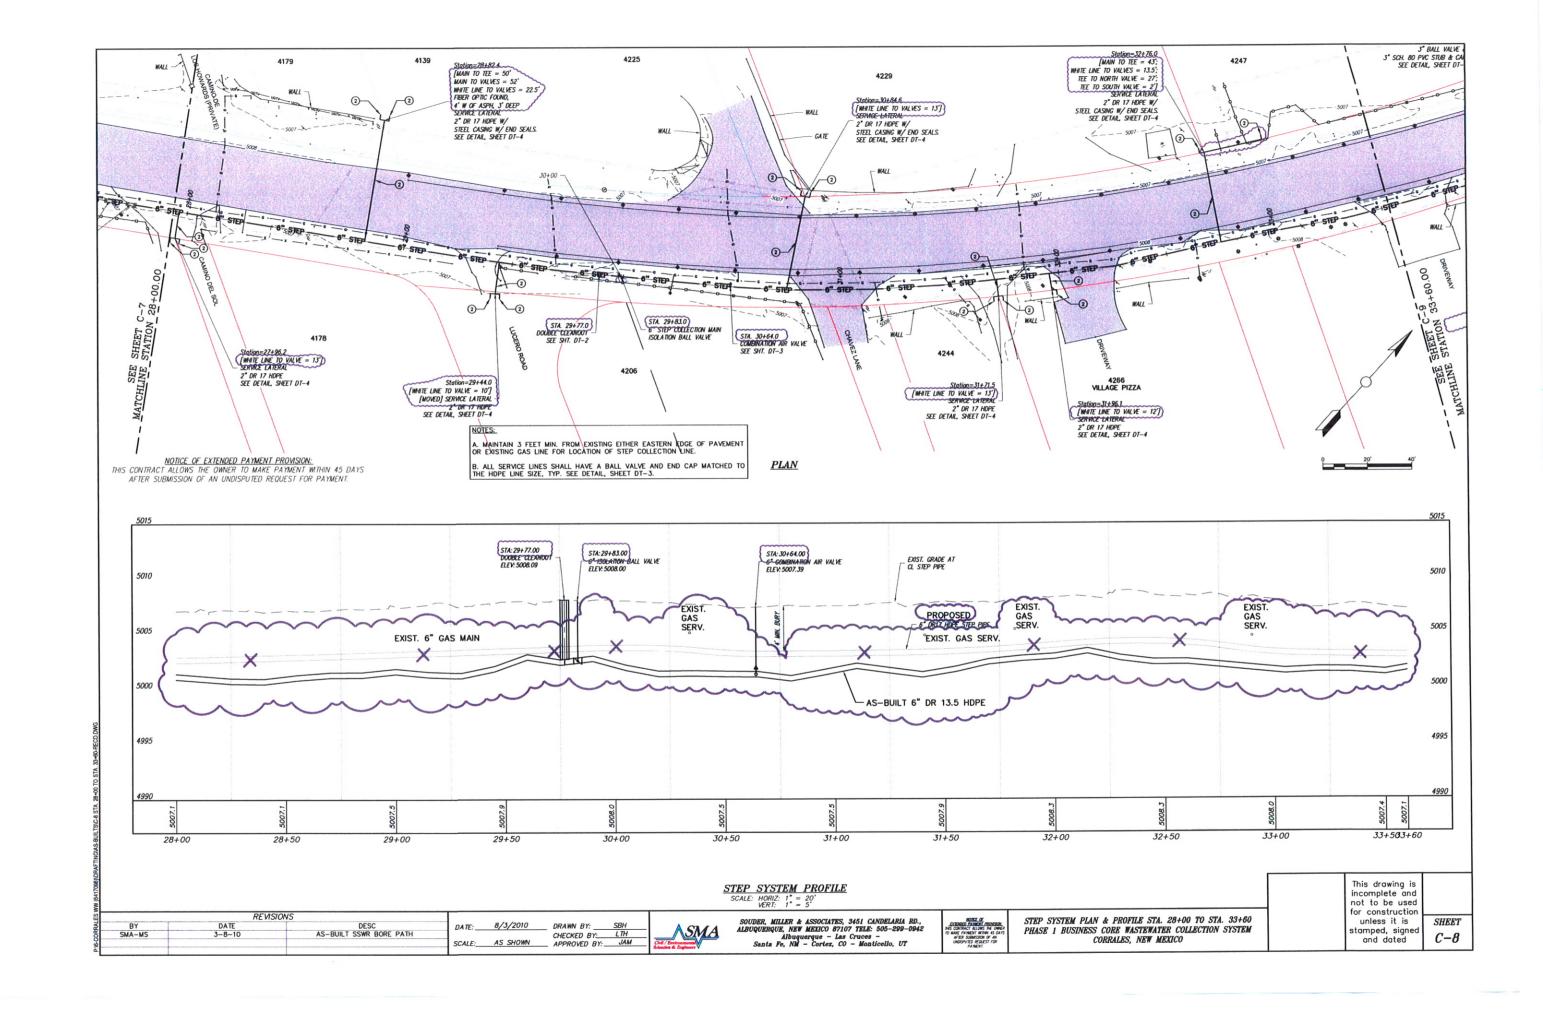


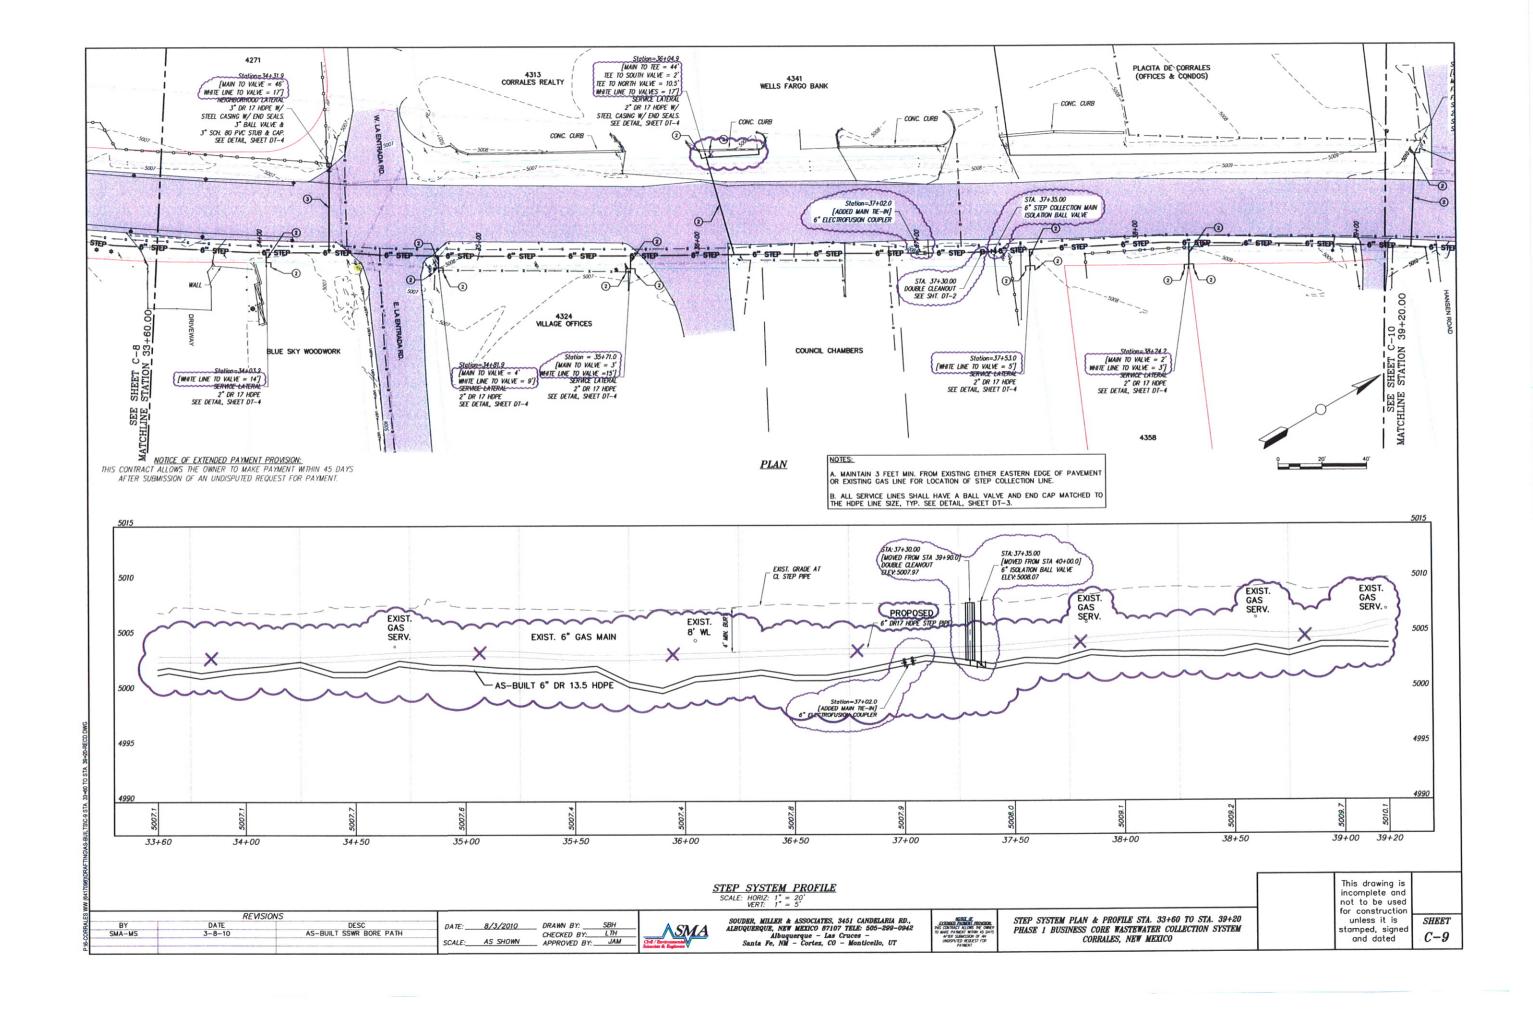


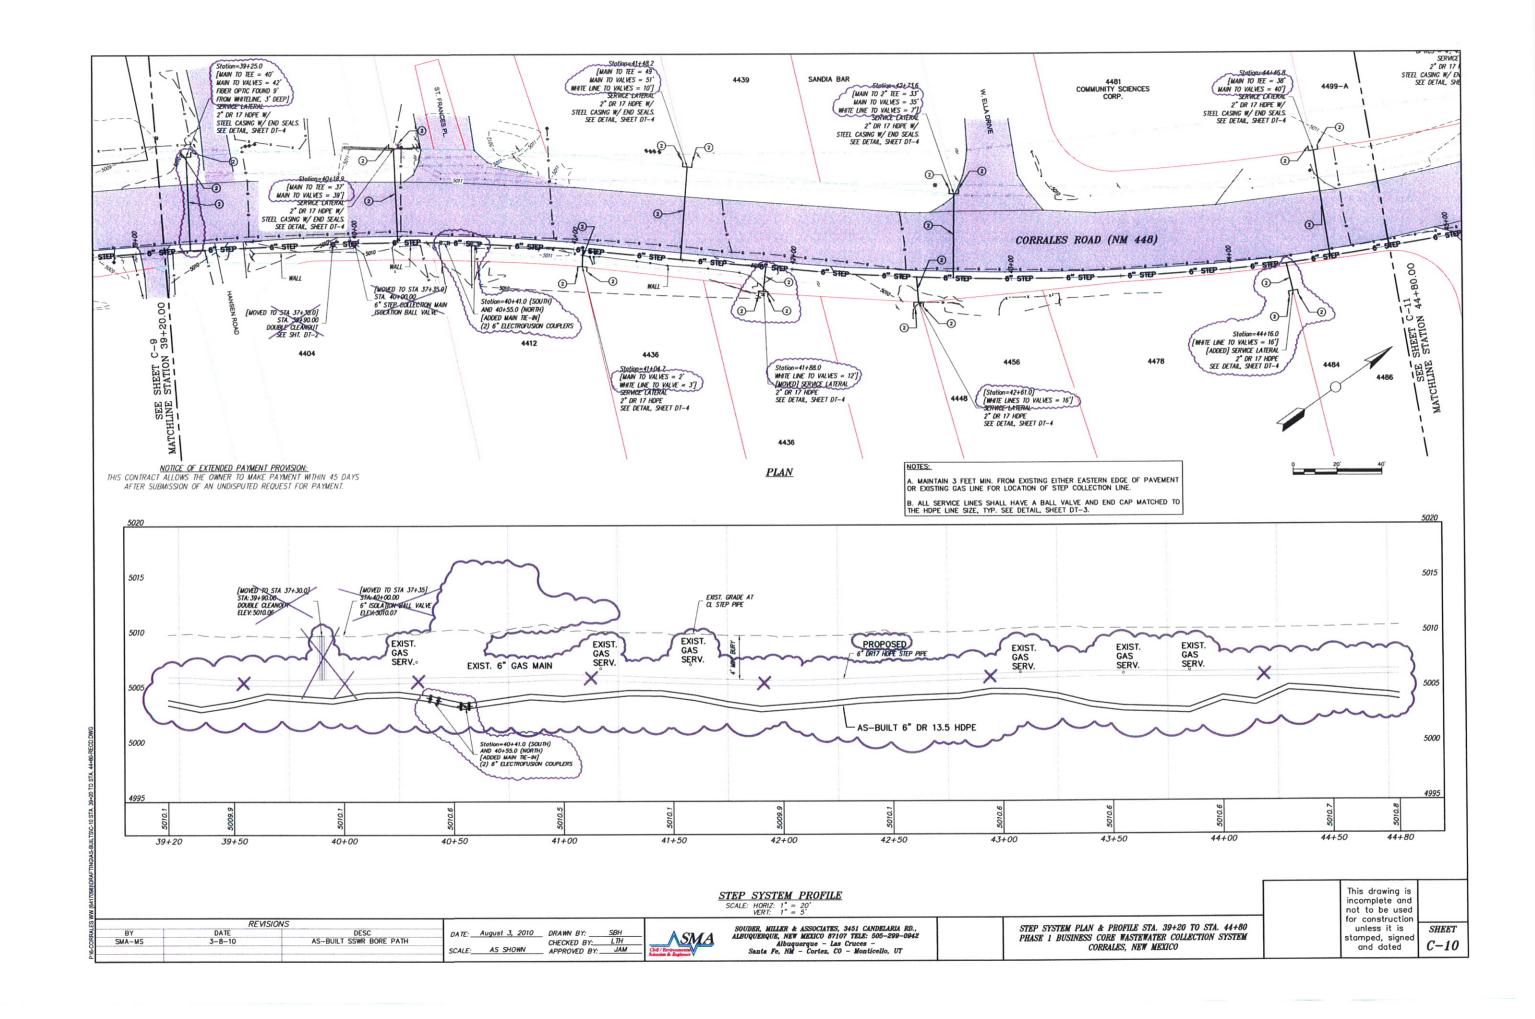


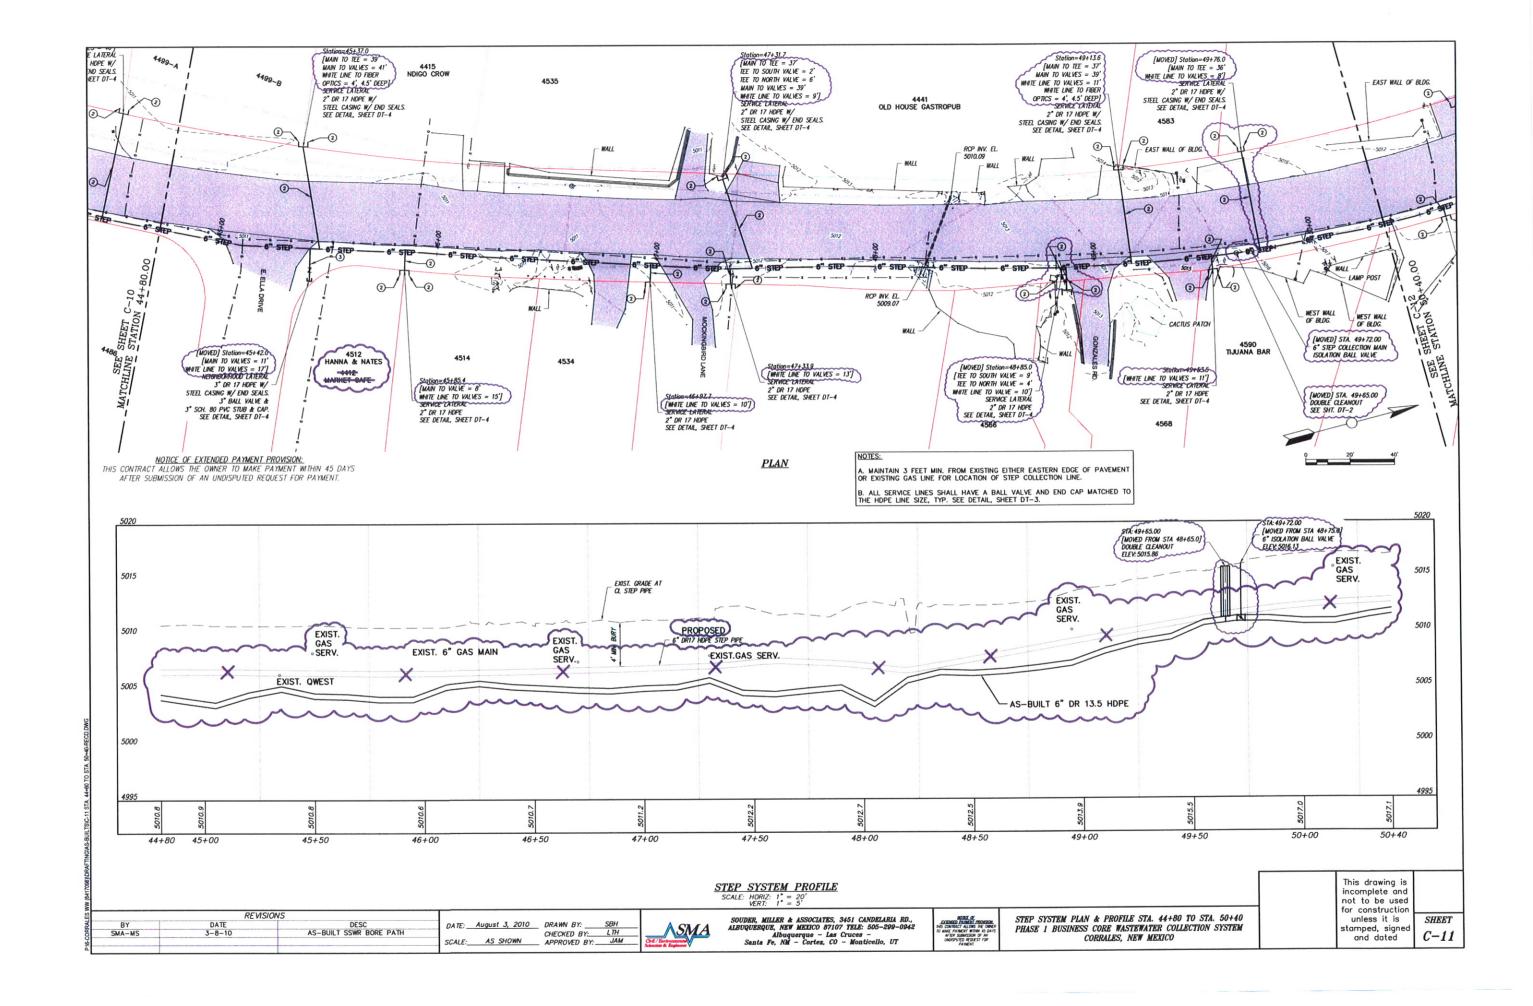


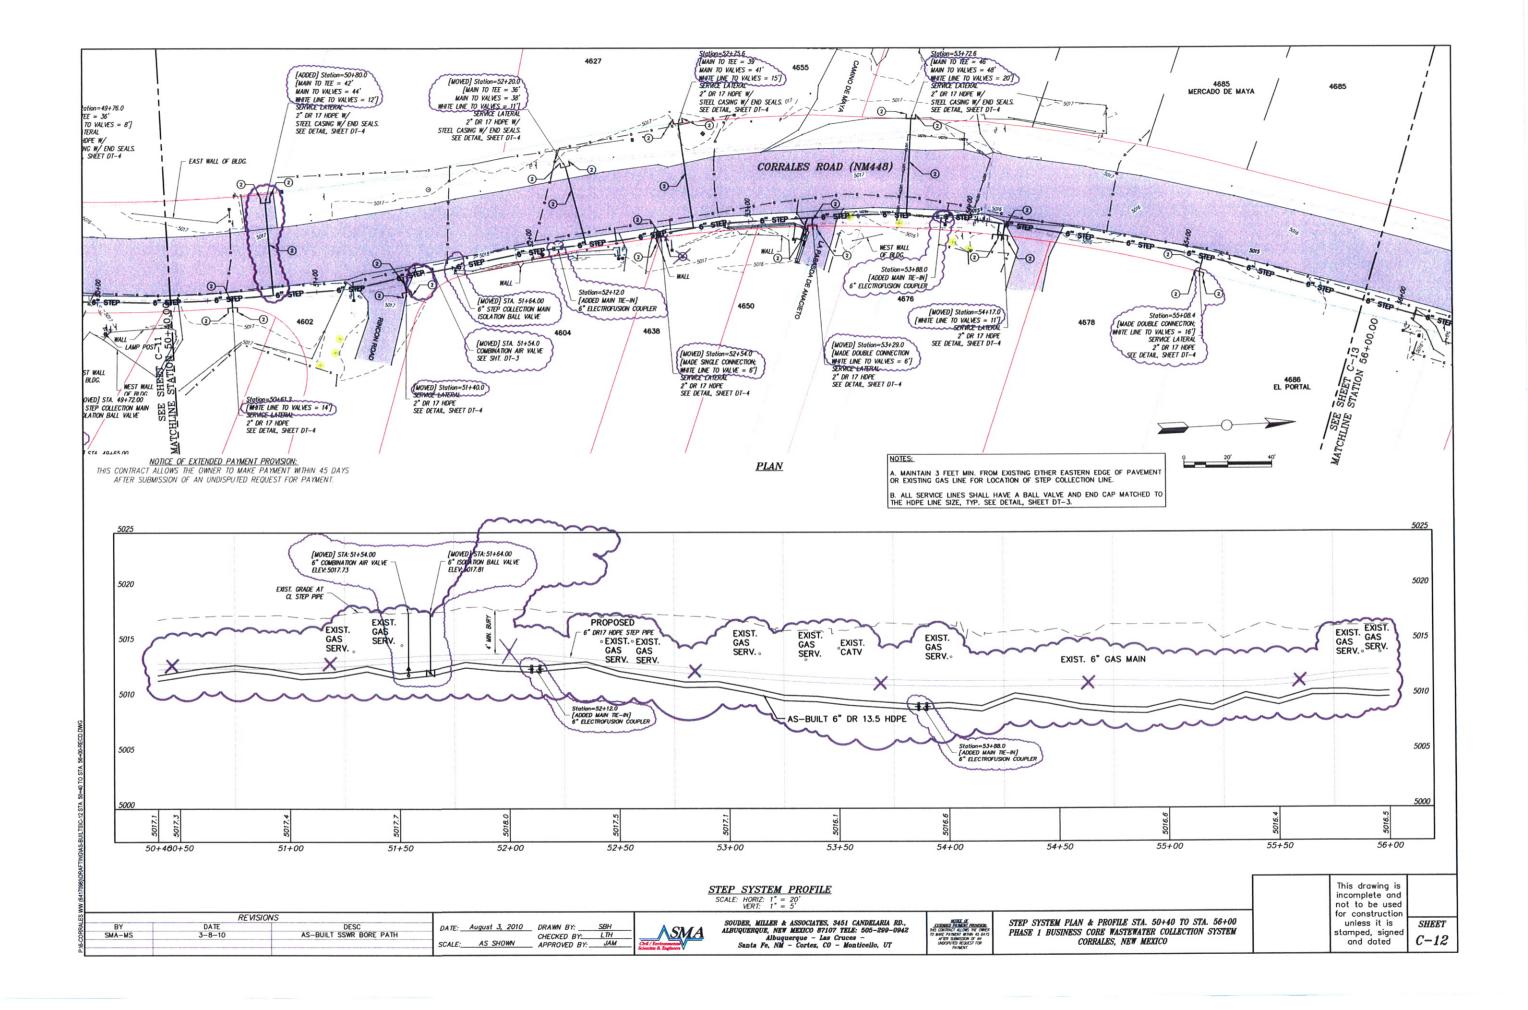


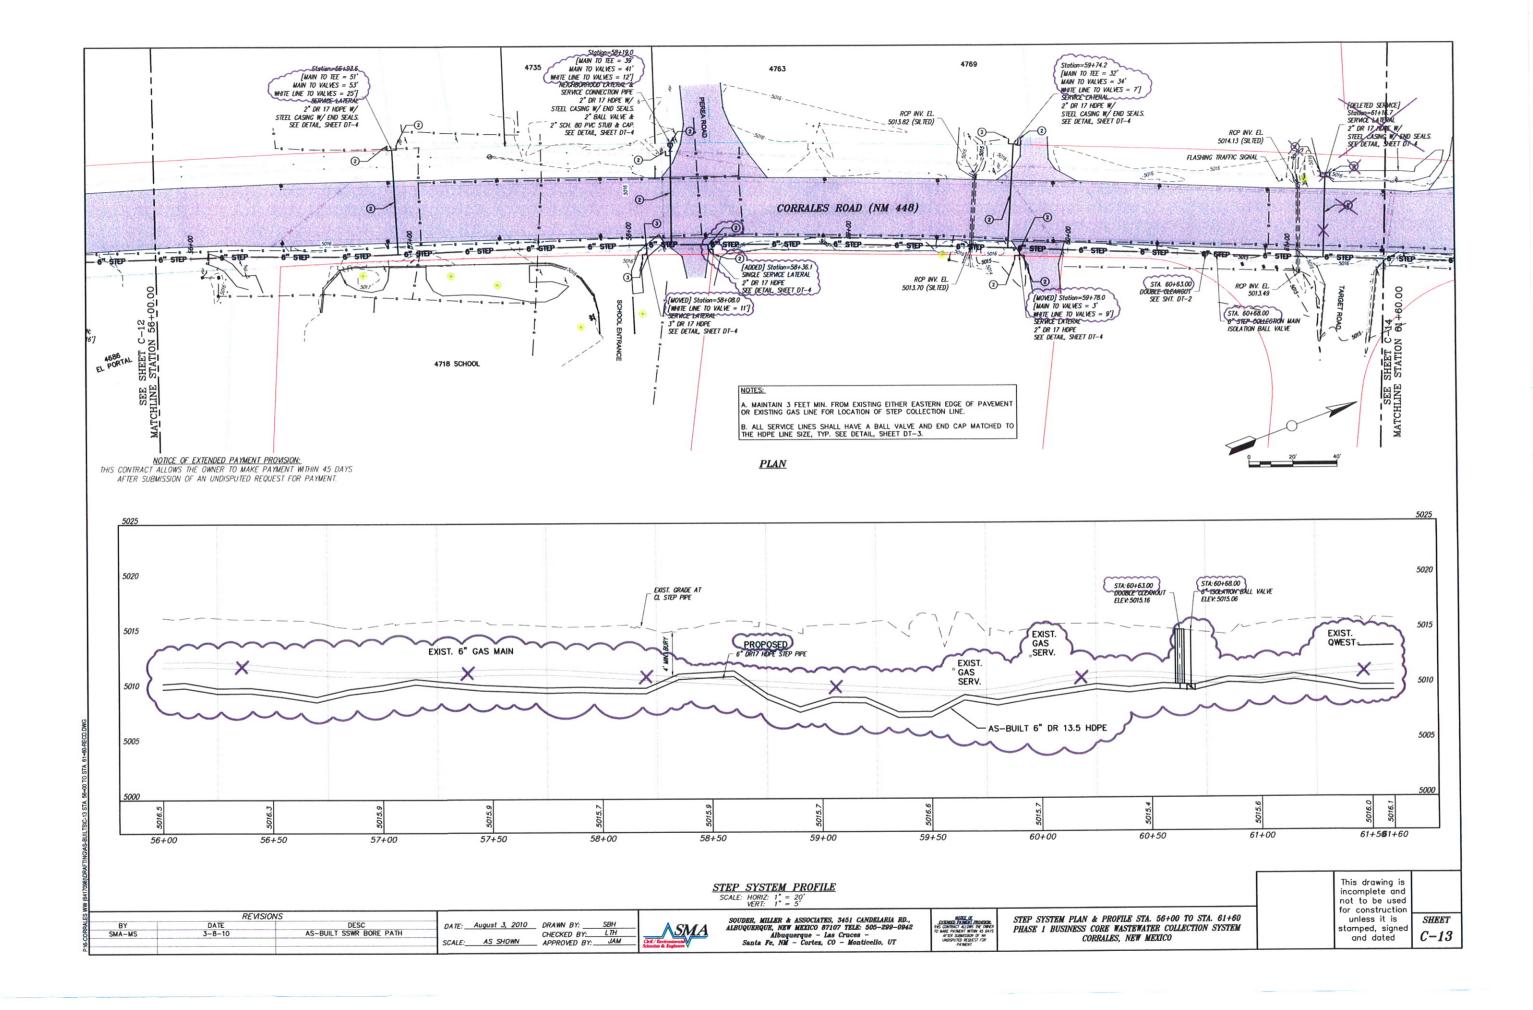

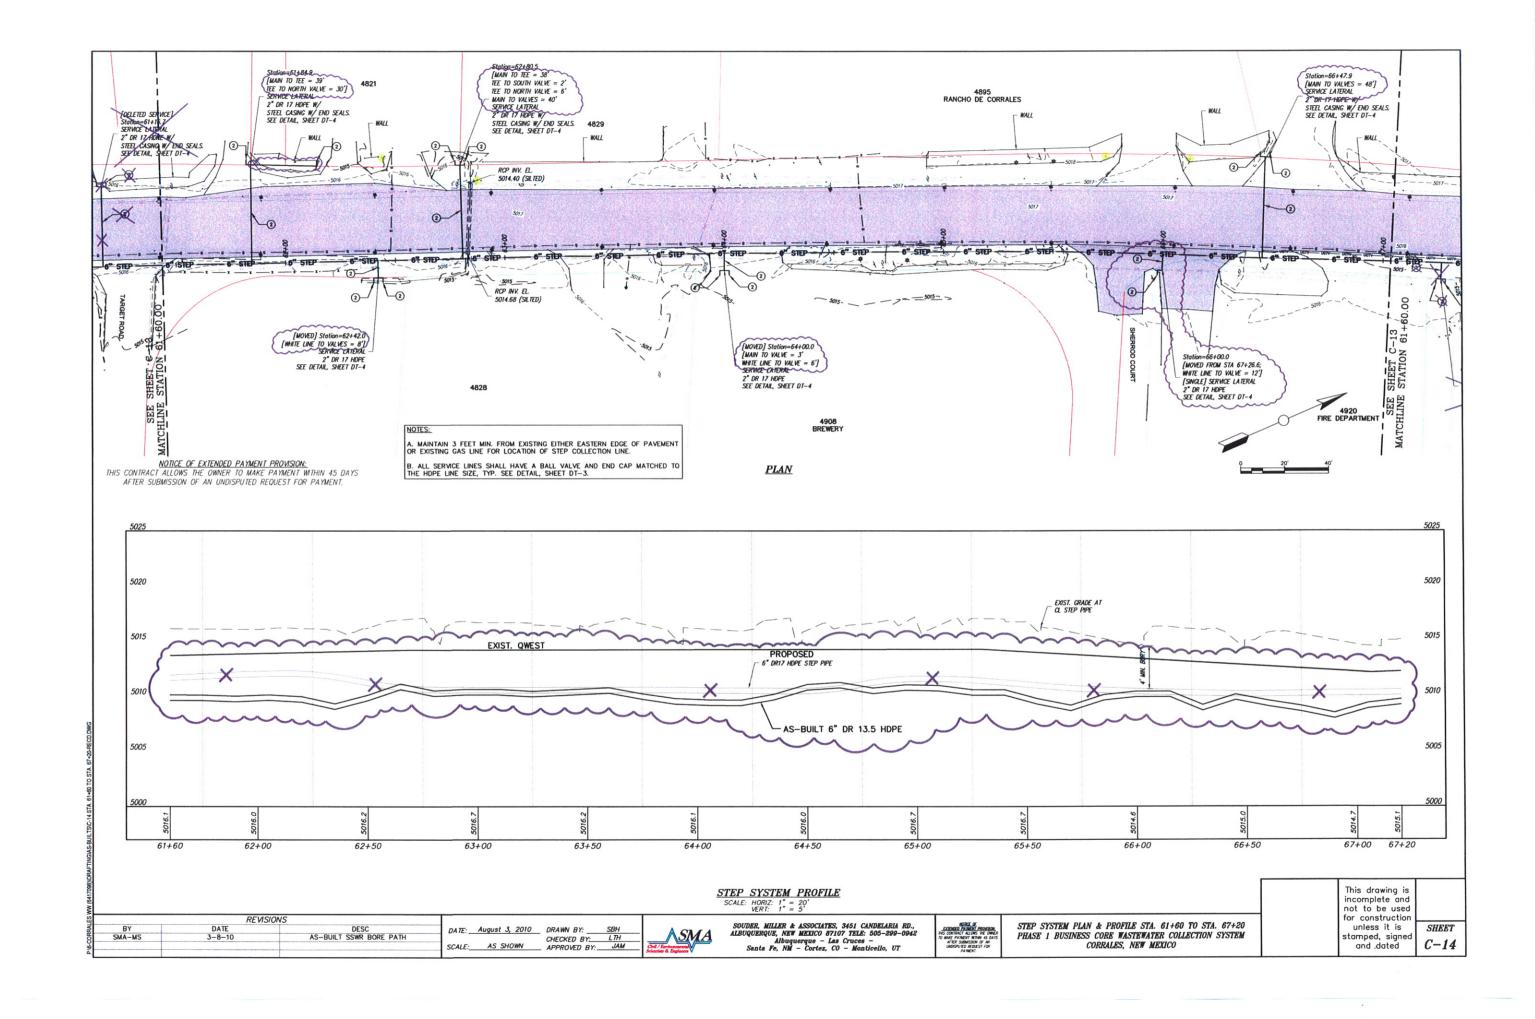

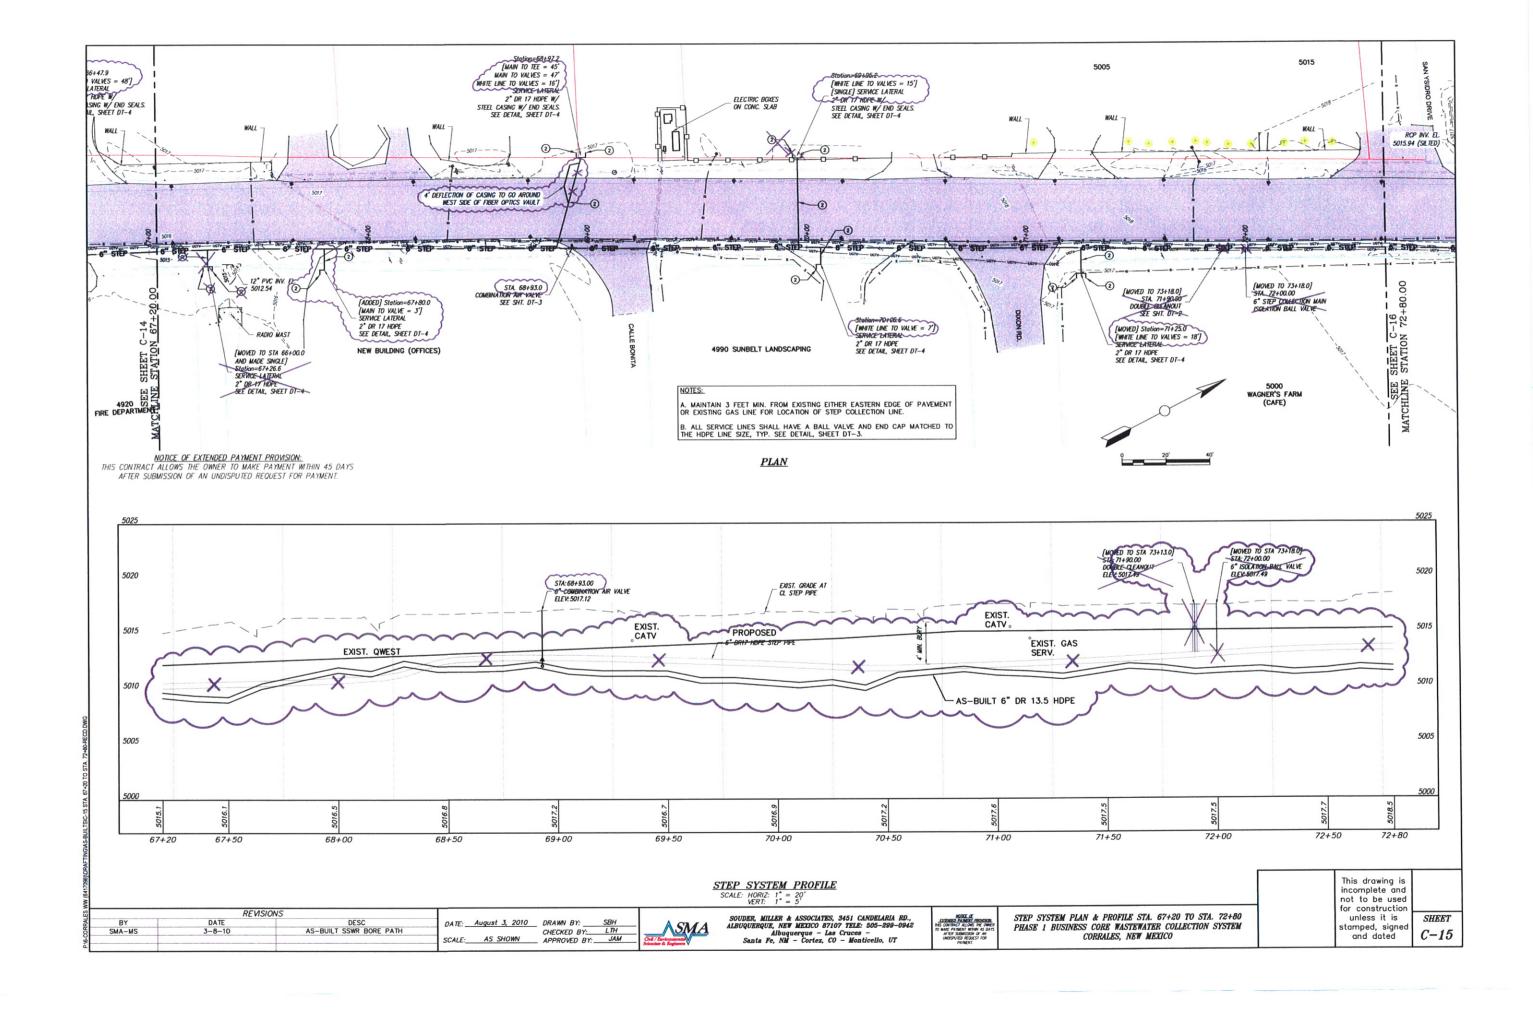


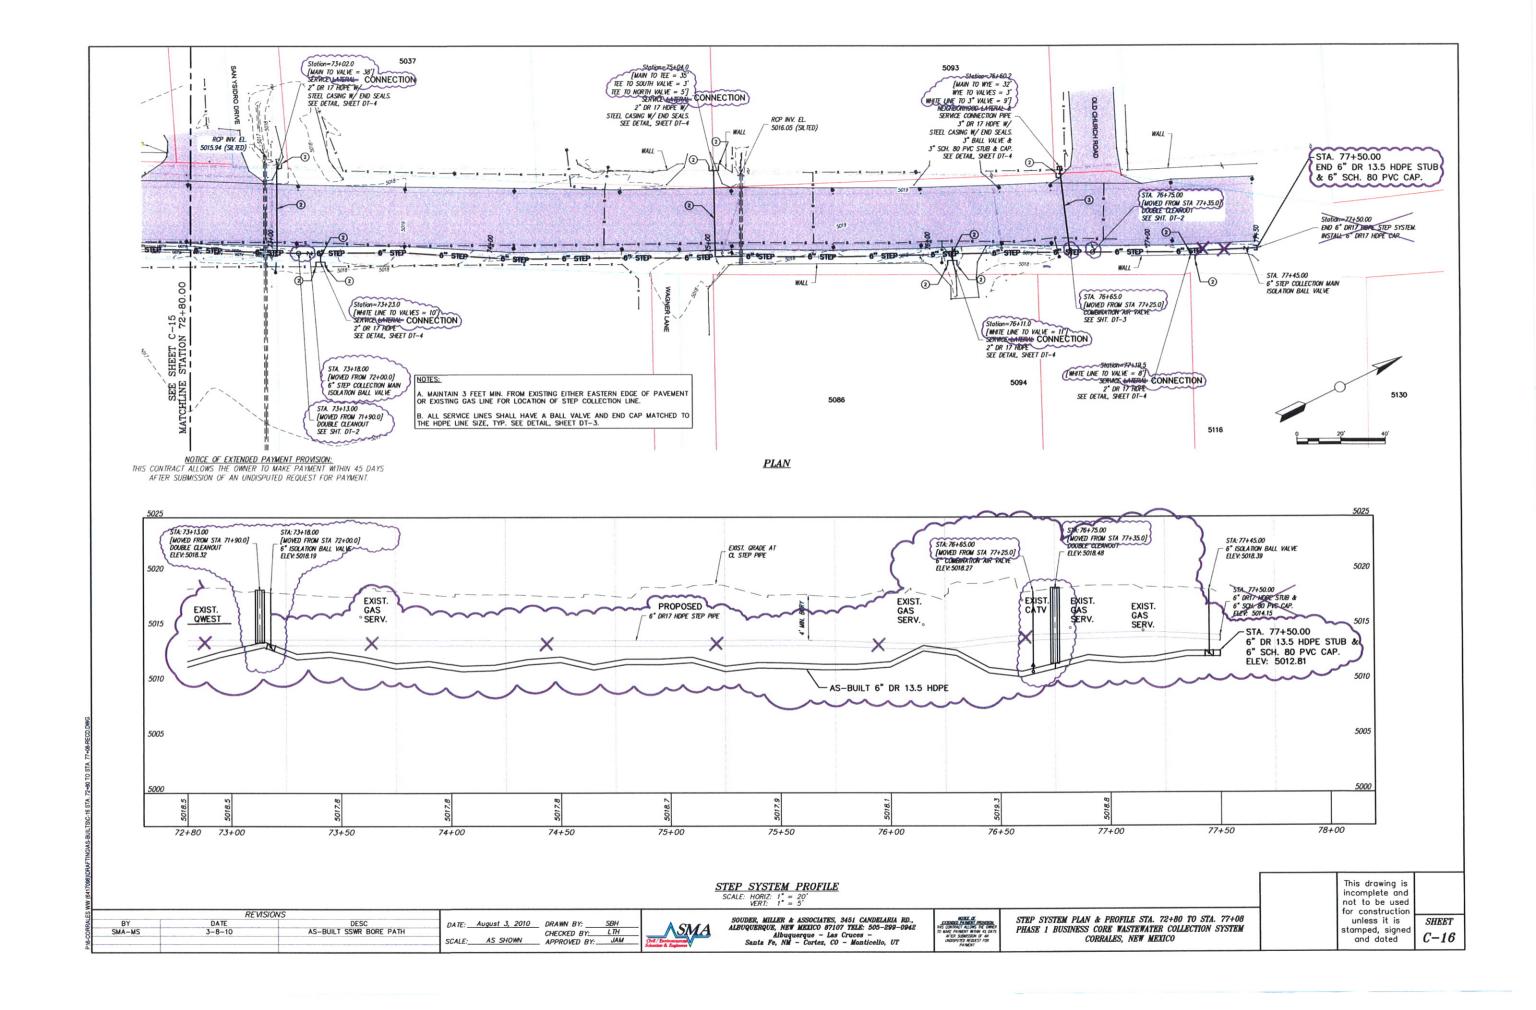


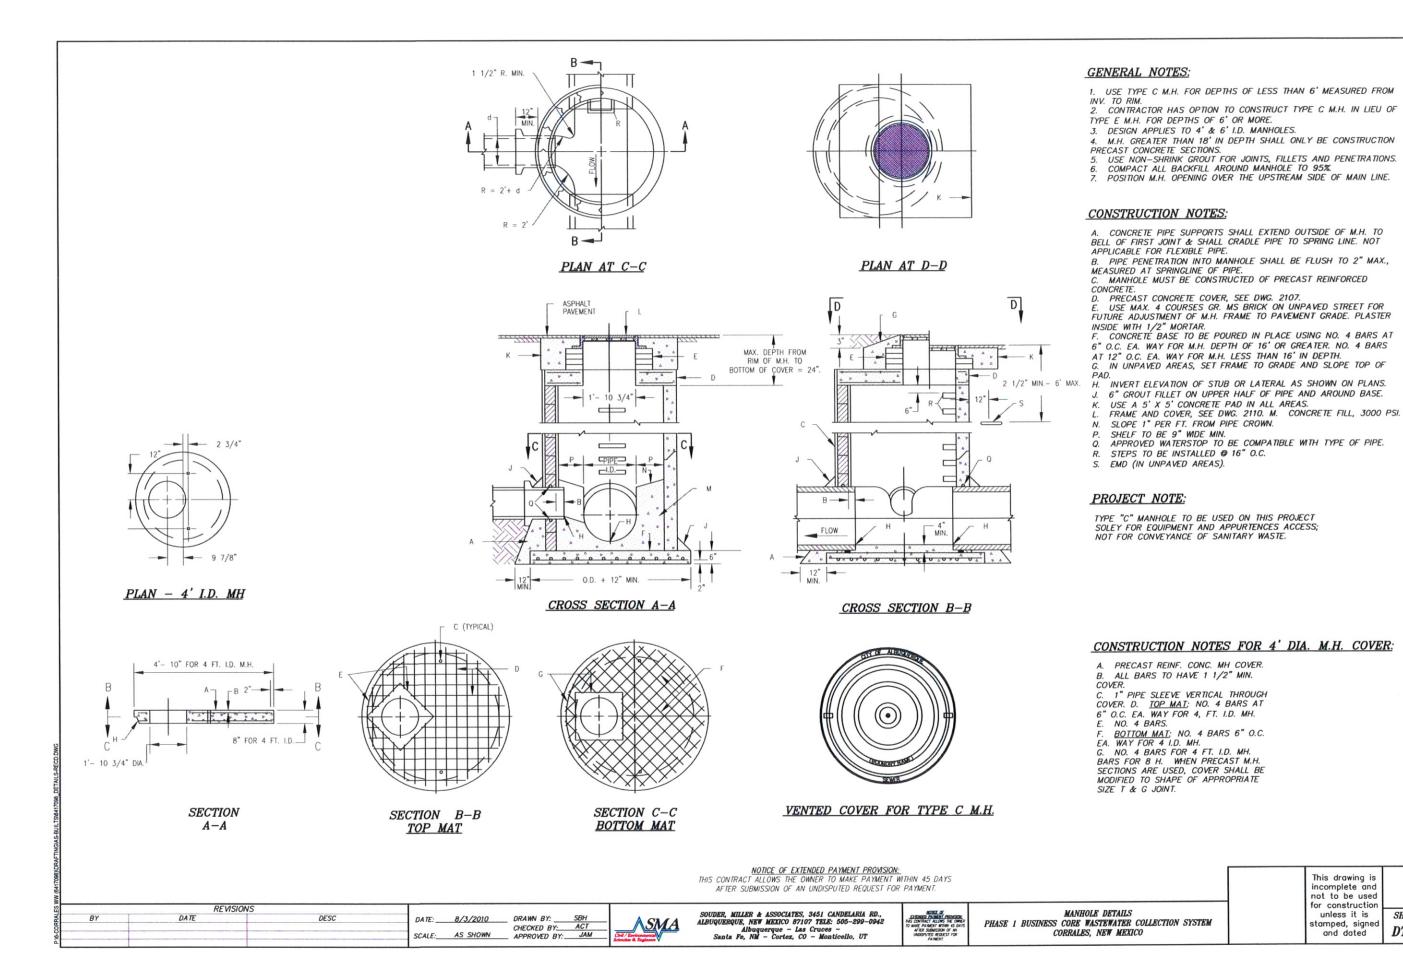

SHEET

DT-1

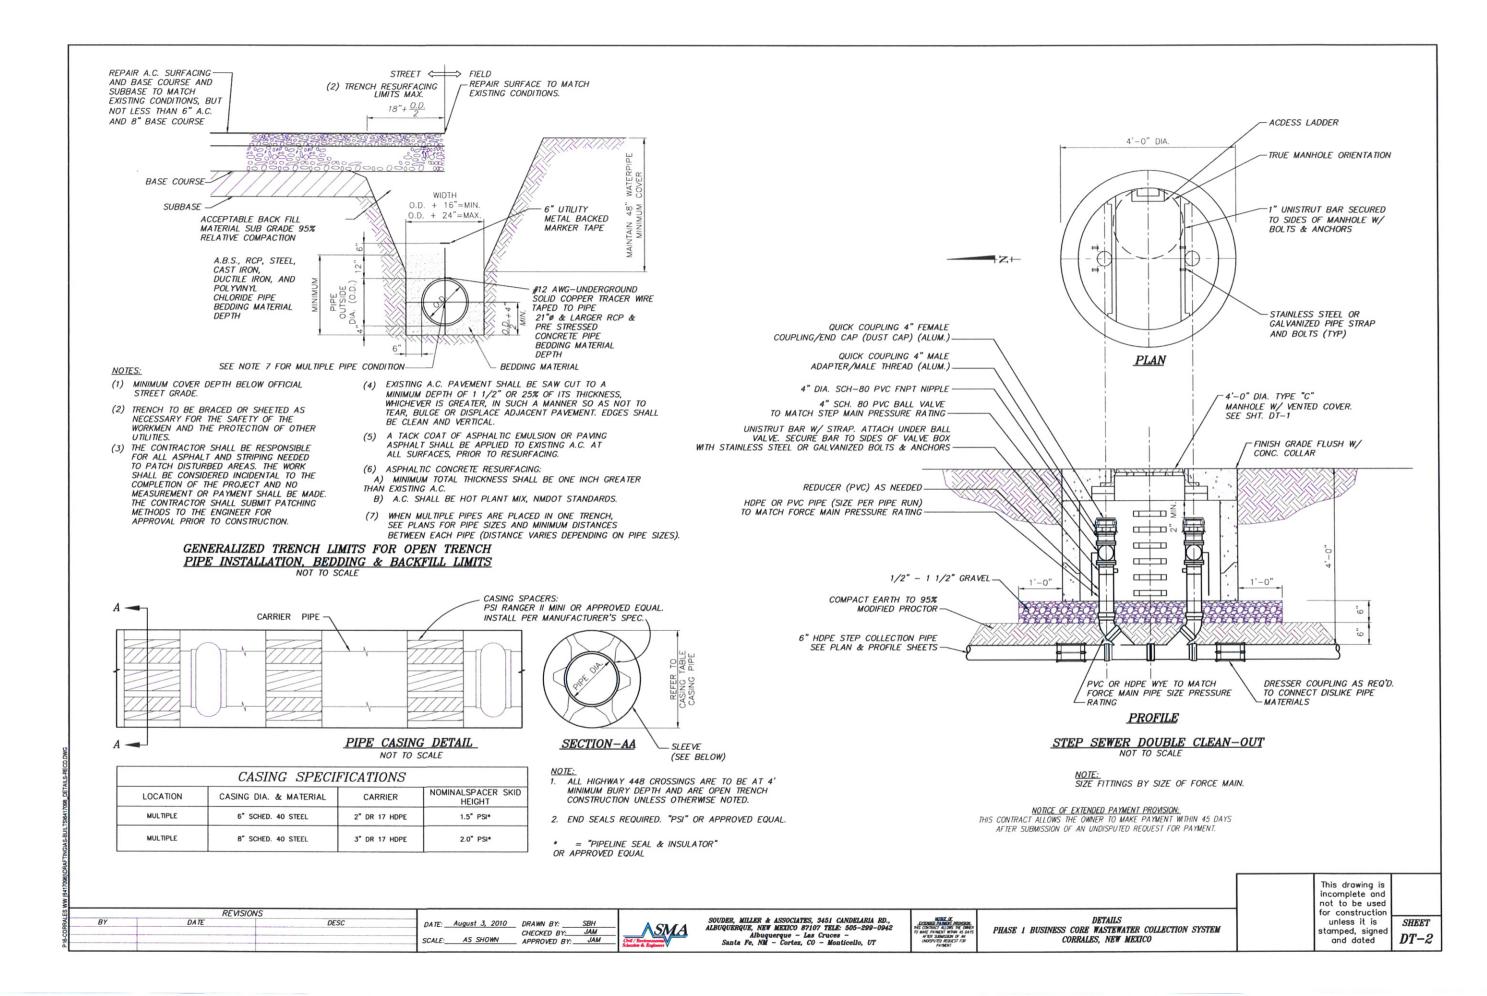

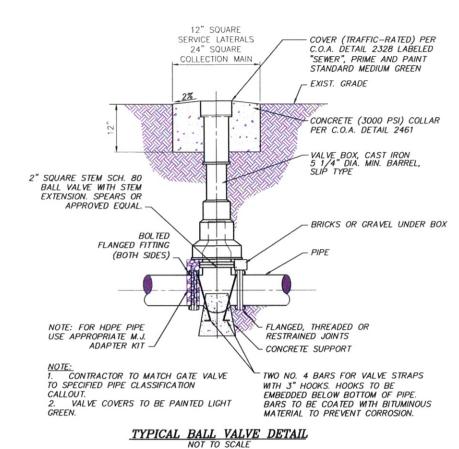

-4'-0" DIA. TYPE "C" MANHOLE W/ VENTED COVER. SEE SHT. DT-1 2" QUICK CONNECT W/ 100psi REINF. HOSE - FINISH GRADE 2" SCH. 80 PVC PIPE & FITTINGS -OFFSET AS REQUIRED TO PROVIDE CLEAR ACCESS 2" VAL-MATIC COMBINATION AIR VALVE, MODEL NO. 802A OR APPROVED EQUAL. SUPPORT WITH UNISTRUT CONNECTED TO MANHOLE WALLS. PACKAGED VENTED AIR ODOR CONTROL UNIT W/ AIR INLET 2" SCH. 80 PVC BALL VALVE-"ODOR CONTROL SPECIALTIES"

MODEL OCU 1214 OR APPROVED 6" S.S. OR HDPE SADDLE W/ 2' NPT CONNECTION -16" WIDE x 16" TALL x 1/8" 6" HDPE STEP COLLECTION PIPE PRIMED & PAINTED STEEL HANGER ATTACHED TO WALL W/ S.S. ANCHOR BOLTS PRIMED AND PAINTED ADJUSTABLE PIPE SUPPORT, MAY BE DRILLED IN TO CONCRETE FLOOR; "NATIONAL PIPE -4" CLEARANCE HANGER CORPORTATION" ITEM #515, OR EQUAL-

STEP PIPING COMBO AIR VALVE DETAIL

NOT TO SCALE

NOTICE OF EXTENDED PAYMENT PROVISION: THIS CONTRACT ALLOWS THE OWNER TO MAKE PAYMENT WITHIN 45 DAYS AFTER SUBMISSION OF AN UNDISPUTED REQUEST FOR PAYMENT.

BY DATE DESC DATE: 8/3/2010 DRAWN BY: SBH
CHECKED BY: ACT
SCALE: AS SHOWN APPROVED BY: JAM

SMA


SOUDER, MILLER & ASSOCIATES, 3451 CANDELARIA RD., ALBUQUERQUE, NEW MEXICO 87107 TELE: 505-299-0942 Albuquerque - Las Cruces -Santa Fe, NM - Cortex, CO - Monticello, UT

MOTICE OF DEMONST PROMISES PARKET PROMISES PER ON THE PROMISES PER ON THE PER

VALVE DETAILS
PHASE 1 BUSINESS CORE WASTEWATER COLLECTION SYSTEM
CORRALES, NEW MEXICO

This drawing is incomplete and not to be used for construction unless it is stamped, signed and dated

SHEET
DT-3

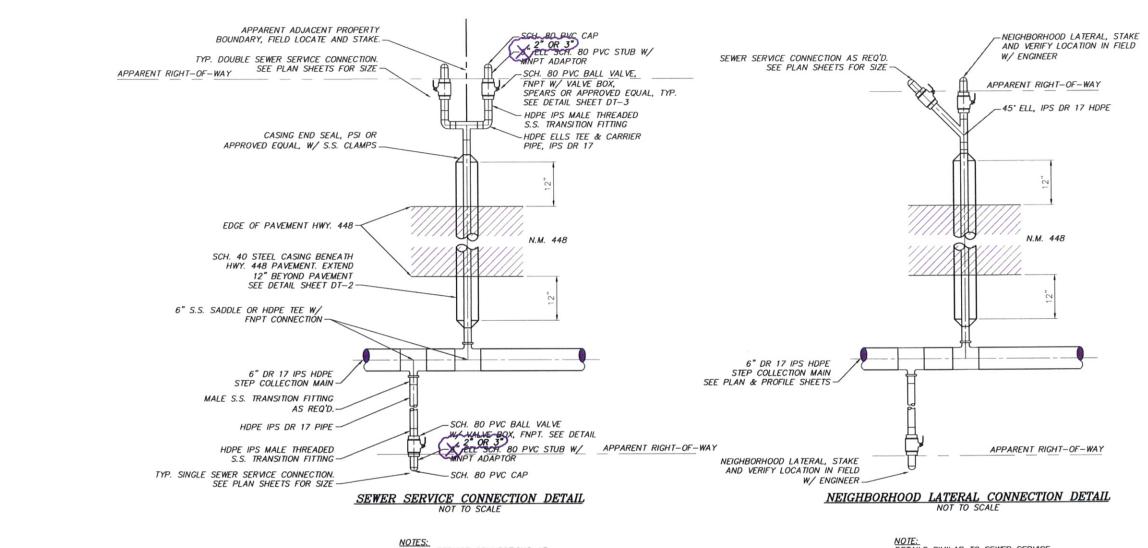

NOTES:

1. STOP SERVICE CONNECTIONS AT APPARENT EDGE OF PROPERTY/ROW

2. CONFIRM ALL SERVICE LOCATIONS IN THE FIELD W/ ENGINEER.

NOTE: DETAILS SIMILAR TO SEWER SERVICE CONNECTION DETAILS.

NOTICE OF EXTENDED PAYMENT PROVISION: THIS CONTRACT ALLOWS THE OWNER TO MAKE PAYMENT WITHIN 45 DAYS AFTER SUBMISSION OF AN UNDISPUTED REQUEST FOR PAYMENT.

REVISIONS
BY DATE DESC DATE: August 3, 2010 DRAWN BY: SBH
SMA/MS 3-4-10 AS-BUILT, EDIT TEXT CHECKED BY: ACT
SCALE: AS SHOWN APPROVED BY: JAM



SOUDER, MILLER & ASSOCIATES, 3451 CANDELARIA RD., ALBUQUERQUE, NEW MEXICO 87107 TELE: 505-299-0942 Albuquerque - Las Cruces -Santa Fe, Nil - Cortes, CO - Monticello, UT

EXPOSED A MANDET PROVISION.

PAS CONTRACT ALLOWS BE OWNER TO MAKE PARKENT WHIN AS DAYS

AFER SLEMISSION OF AN UNDERFARE PORTURN.

PARKENT.

SERVICE CONNECTION DETAILS
PHASE 1 BUSINESS CORE WASTEWATER COLLECTION SYSTEM
CORRALES, NEW MEXICO

This drawing is incomplete and not to be used for construction unless it is stamped, signed and dated

s SHEET DT-4

